#### Planning Permit Application Form

#### Parining statement statement of the stat

455 County Center, 2nd Floor • Redwood City CA 94063 Mail Orop: PLN 122 • TEL [650] 363-4161 • FAX [650] 363-4849 www.co.sanmateo.ca.us/planning

Application Form	www.co.sanmateo.ca.us/pianning PLN:
- *	BLD:
Applicant: Xuan Jlang& Chuwen Lin	
Mailing Address: 141 Santa Helena Ave Apt 5#	
San Bruno, CA	Zip: 94066
Phone, W: 4155898521	н: 4156370155
E-mail Address: sally08880771@gmail.com	FAX:
Name of Owner (1): Xuan Jlang	Name of Owner (2): Chuwen Lin
Mailing Address: 141 Santa Helena Ave	Mailing Address: 141 Santa Helena Ave
Apt 5#	Apt 5#
San Bruno, CA zip: 94066	San Bruno, CA zip: 94066
Phone,W: 4155898521	Phone,W: 4156370155
Н:	Н:
E-mail Address: sally08880771@gmail.com	E-mail Address: chuwen.lin@gmail.com
Colst moments	
Project Location (address):	Assessor's Parcel Numbers: 37 — 186 — 210
Marine Blvd-(No street number)	
Moss Beach, CA, 94038	
Zoning: R-1-S-17-DR-CD	Parcel/lot size: 3,800 SF (Square Feet)
List all elements of proposed project: (e.g. access, size a	nd location, primary and accessory structures, well, septic, tank)
We are looking to build a modest two story single famil	ly residence with attached garage. Style and materials have
been chosen to be compatible with the design and with	n the neighborhood.
Describe Existing Site Conditions/Features (e.g. topogra	aphy, water bodies, vegetation):
Property is a small vacant lot without unique characteri	istics.
There is little topography, nearly flat. No streams or wi	
No notable vegetation or trees.	
Describe Existing Structures and/or Development:	
Property is vacant.	
	d on forms, plans and other materials submitted herewith in suppo knowledge. It is our responsibility to inform the County of San Mate o information represented in these submitalls
Owner's signature: Xuan Jiang O	6/21/2016
Owner's signature:	
Applicant's signature: Xuan Jiana (	Thru Ji

## Application for Design Review by the County Coastside Design

#### Filanairote are cultural Displacement

County Government Center # 455 County Center # Redwood City CA 94063 Mail Drop PLN 122 # 650 • 363 • 4161 # FAX 650 • 363 • 4849

Permit #: PLN		
Other Permit #	#:	

Review Committee	Other Permit #:		
in fall and the second			
Applicant:	Owner (if different from Applicant):		
Name: Xuan Jlang& Chuwen Lin	Name: Xuan Jlang& Chuwen Lin		
Address: 141 Santa Helena Ave Apt 5#	Address: 141 Santa Helena Ave Apt 5#		
San Bruno, CA Zip: 94066	San Bruno, CA Zip: 94066		
Phone, W: 4155898521 H: 4156370155	Phone, W: 4155898521 H: 4156370155		
Email: sally08880771@gmail.com	Email: sally08880771@gmail.com		
Architect or Designer (if different from Applicant):  Name: Everett Smith - Designer			
Address: 270 E. Douglas Avenue, El Cajon, CA	Zip: <b>94066</b>		
Phone,W: 9513232187 H:	Email: everett@cuttingedgehomes.net		
Project location:  APN: 37186210	Site Description:  Vacant Parcel		
Address: Marine Blvd - (No street number)	Existing Development (Please describe):		
Moss Beach, CA Zip: 94,038	This is a small vacant parcel with very little slope.		
Zoning: R-1-S-17-DR-CD			
Parcel/lot size: 3800 sq. ft.			
sprojeture pertuin			
Project:	Additional Permits Required:		
■ New Single Family Residence: sq. ft	☐ Certificate of Compliance Type A or Type B		
☐ Addition to Residence: sq. ft	Coastal Development Permit		
Other:	☐ Fence Height Exception (not permitted on coast)		
	☐ Grading Permit or Exemption		
Describe Project:	☐ Home Improvement Exception		
This is a vacant parcel where we intend on building	☐ Non-Conforming Use Permit		
a modest two story home with two car attached	☐ Off-Street Parking Exception		
garage, consistent with neighborhood character.	□ Variance		

Fill in Blanks:	Material	Color/Finish	Check if matches
		(If different from existing, attach sa	<b>existing</b> ample)
a. Exterior walls	Fiber-Cement Siding	Eucalyptus Tree	
b. Trim	Craftsman Style	White	
c. Windows	Vinyl	White	
d, Doors	Wood or similar	White	
e. Roof	Architect. Composite Shingle	Driftwood	
f. Chimneys	N/A		
g. Decks & railings	Composite	Grey	
h. Stairs	Trex Type Decking	Light Grey	
i. Retaining walls	None		
j, Fences	None		_
k. Accessory buildings	None		
I. Garage/Carport	Attached - Same Materials	Eucalyptus Tree	_
including the required find applicable to the location (optional) Application (optional) Ap	ion, the County must determine that this prindings that the project does conform to the nof the project pursuant to Section 6565.1 ant's Statement of project compliance with a statement of the best of my known is true and correct to the best of my known in the statement of t	e standards and guidelines for desi 0. standards and guidelines (check if a ns, and other materials submitted i	gn review attached). herewith in
San Mateo through my a	assigned project planner of any changes to  Any Applica	information represented in these s	submittals.
Owner:	Applica Applica	nt:	- Vacator
6/21/2016 Date:	<u>ь/.</u> Date:	21/2016	

			Sa		

#### **Environmental Information Disclosure Form**

FIE	mili	(g) (e) (	10. (E)	iflei	lig).	(D): <sub>[</sub> (	ielal	n(e)	
					_				
LD									

Moss Beach, CA	Address: 141 Santa Helena Ave APT 5#		
94038	San Bruno, CA Phone: 4155898521		
Assessor's Parcel No.: 37 — 186 — 210	Name of Applicant: Xuan Jiang& Chuwen Lin		
_	Address: 141 Santa Helena Ave APT 5#		
Zoning District: R-1-S-17-DR-CD	San Bruno, CA Phone: 4155898521		
Existing Site Conditions			

Describe the extent and type of all existing development and uses on the project parcel, including the existence and purpose of any easements on the parcel, and a description of any natural features on the project parcel (i.e. steep terrain, creeks, vegetation).

We are looking to build a modest two story single family residence with attached garage. This is a small

We are looking to build a modest two story single family residence with attached garage. This is a small

vacant land. There is no easements on the parcel. There is no visible vegetation.

s	No	Will this project involve:
		a. Addition to an existing structure > 50% of the existing area OR > 2,500 sq. ft?
	ANGEN HER ANG	b. Construction of a new multi-family residential structure having 5 or more units?
	- I	c. Construction of a commercial structure > 2,500 sq.ft?
	NOPPORTURE VARIA	<ul> <li>d. Removal of mature tree(s) ( ≥ 6" d.b.h. in Emerald Lake Hills area or ≥ 12" d.b.h. in any residential zoning district)?</li> <li>If yes, how many trees to be removed?</li> </ul>
		e. Land clearing or grading?  If yes, please state amount in cubic yards (c.y.):  Excavation:  c.y.  c.y.
		f. Subdivision of land into 5 or more parcels?
		g. Construction within a State or County scenic corridor?
	Time Services	h. Construction within a sensitive habitat?
]_		i. Construction within a hazard area (i.e. seismic fault, landslide, flood)?
_]_		j. Construction on a hazardous waste site (check with Co. Env. Health Division)?
ase	explair	all "Yes" answers:

Signature required on reverse →

2. Na	tional l	Marine Fisheries Rule 4(d) Review
Yes	No	Will the project involve:
	X	a. Construction outside of the footprint of an existing, legal structure?
	$oxed{oxed}$	b. Exterior construction within 100-feet of a stream?
	X	c. Construction, maintenance or use of a road, bridge, or trail on a stream bank or unstable hill slope?
		d. Land-use within a riparian area?
	X	eTimber harvesting, mining, grazing or grading?
		f. Any work inside of a stream, riparian corridor, or shoreline?
$\square$ _		g. Release or capture of fish or commerce dealing with fish?
Please	explain	any "Yes" answers:
. Nat ∕es	ional P	ollutant Discharge Elimination System (NPDES) Review  Will the project involve:
		a. A subdivision or Commercial / Industrial Development that will result in the addition or replacement or
<del></del>		10,000 sq. ft. or more of impervious surface?
		If yes, Property Owner may be required to implement appropriate source control and site design measures and to design and implement stormwater treatment measures, to reduce the discharge of stormwater pollutants. Please consult the Current Planning Section for necessary forms and both construction and post-construction requirements.
		b. Land disturbance of 1 acre or more of area?
841 (10.1.1.1.1.1.1.1.1.1.1.1.1.1.1.1.1.1.1.	$\boxtimes$	If yes, Property Owner must file a Notice of Intent (NOI) to be covered under the statewide General Construction Activities Storm Water Permit (General Permit) <u>prior</u> to the commencement of construction activity. Proof of coverage under State permit must be demonstrated prior to the issuance of a building permit.
		ion
ereb	y certify	that the statements furnished above and in the attached exhibits present the data and
orma	ition red	quired for this initial evaluation to the best of my ability, and the facts, statements and
		esented are true and correct to the best of my knowledge and belief. If any of the need here change, it is my responsibility to inform the County.
gned:	: Xna	n Jinny Churchi Date: 6/21/2016
	(A	pplicant may sign)

San Mateo County

#### ्रिविमानां विक्राहार विकास स्थापना विकास स्थापना विकास स्थापनी विकास स्थापनी विकास स्थापनी विकास स्थापनी विकास

### Certificate of Exemption or Exclusion from a Coastal Development Permit

Permit #: PLN \_\_\_\_

455 County Center, 2nd Floor • Redwood City, CA • 94063 Mail Drop: PLN 122 • TEL (650) 363-4161 • FAX (650) 363-4849

> Permanent Record Microfilming Required

Permit #: BLD	Wilcionining Required
if Effection in the second	
Owner Name: Xuan Jiang & Chuwen Lin	Applicant Name: Xuan Jiang & Chuwen Lin
Address: 141 Santa Helena Ave APT 5#	Address: 141 Santa Helena Ave APT 5#
San Bruno, CA	San Bruno, CA
Zip: 94066	Zip: 94066
Phone,W: 4155898521 H: 4156370155	Phone, W: 4155898521 H: 4156370155
Email Address: sally08880771@gmail.com	Email Address: sally08880771@gmail.com
2 Hope Indinetion - 1	
Assessor's Parcel Number(s):  37 — 186 — 210 — — —	Existing water source:  Utility connection  Proposed water source:  Utility connection  Well  Staking of well location and property lines are required.  Provide site plan depicting location and all trees.  Will this require any grading or vegetation/tree removal? Yes IND IND  If Yes, additional permits may be required. Such as: Tree Removal Permit, Grading Permit, Land Clearing Permit,
basis for exemption or exclusion are true and correct to the bin accordance with the terms of the exemption/exclusion cate	Coastal Development Permit.  sis for this exemption or exclusion. The information herein and the est of our knowledge and we hereby agree to carry out this project egory selected on reverse. We also understand and agree that any e tank in the single family exclusion area will be invalidated in the sa variance.  Xuan Jiang M. L. 4/09/2016  Applicant Date

(Both Owner and Applicant must sign unless this Application for Exemption or Exclusion accompanies a Building Permit Application for which the Applicant is an agent for the Owner acceptable to the Building Inspection Section.)

#### Staff Use Only

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经押:	<u> </u>	
	ched review sheet to determine basis of exemption and v t/owner and initial appropriate category below:	whether project qualifies. Review basis of exemption with
[F B. I C. I D. D.	Improvements to Existing Single Family Residence. PRC 30610[a], CCAG 13250, ZR 6328.5[a]] Improvements to Existing Structure Other Than ingle Family Residence or Public Works Facility. [PRC 0610[b], CCAG 13253, ZR 6328.5[b]] Existing Navigation Channel. [PRC 30610[c], R 6328.5[c]] Repair or Maintenance Activity. PRC 30610[d], CCAG 13252, ZR 6328.5[d]] Single Family Residence Categorical Exclusion Area. PRC 30610[e], CCAG 13240, AB 643, ZR 6328.5[e]]	F. Agriculturally-Related Development Categorical Exclusion Area. [PRC 30610[e], CCAG 13240, ORDERS E-79-7 and E-81=1, -ZR 6328:5[e]]G. Utility Connections. [PRC 30610[f], ZR 6328:5[f]]H. Replacement of Structures Following Disasters. [PRC 30610[g], ZR 6328.5[g]]I. Emergency Activities. [PRC 30611, ZR 6328.5[h]]J. Lot Line Adjustment. [ZR 6328.5[i]]K. Land Division for Public Recreation Purposes. [ZR 6328.5[i]]
☐ Rec	quired 🔲 Not Required	
Inspectio	n made by:	Date of Inspection:
Yes	Removal of trees?  If Yes, is tree removal permit included?  Trimming of trees?  Excessive removal of vegetation?  Excessive grading? (If Yes, CDP is required)  Erosion control plan required?	Approval of Permit is subject to the following: (check if applicable)  Submittal and Approval of a Tree Removal Permit  Submittal and Approval of a Grading Permit  Submittal and Approval of an Erosion Control Plan  Submittal and Approval of a Coastal Dev. Permit
I have reveloped a checked a <b>Exempti</b> Planning		ned that it meets all criteria for the exemption/exclusion  Date
Fee	collected ginal Certificate of Exemption to Building Inspection	Any relevant Planning or Building Inspection files.     California Coastal Commission, 45 Fremont Street,

Suite 2000, San Francisco, CA 94105

\_Update Permit\*Plan Case Screen and Activities

1. Applicant/Owner.


\_Copies of Certificate of Exemption to:

2. Planning Department Exemption Binder.

#### BODY MATERIAL – LEVEL 1 NON-COMBUSTIBLE FIBER-CEMENT LAP SIDING WOOD GRAINED TEXTURE COLOR: FAMILY TREE (PAGE 2)




ACCENT SIDING – FLOOR 2 BOARD N BATTEN SIDING COLOR: FAMILY TREE (PAGE 2)

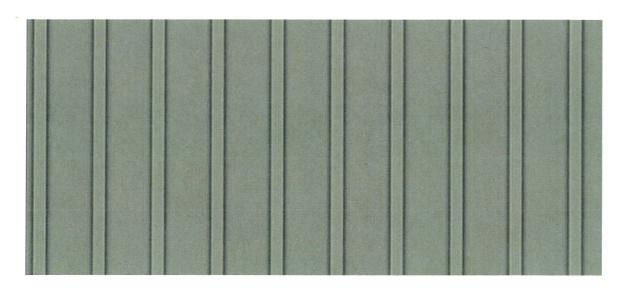


JIANG RESIDENCE - MOSS BEACH


#### Family Tree DET503

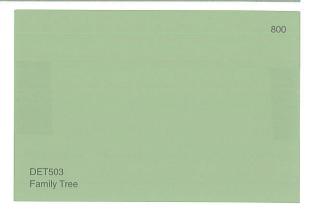

#### SHINGLES AT GABLE WHITE SHAKE

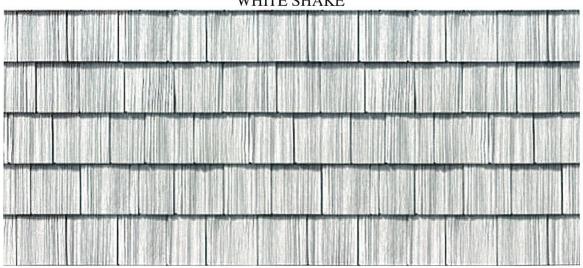


#### EXTERIOR TRIM: WHITE ON WHITE

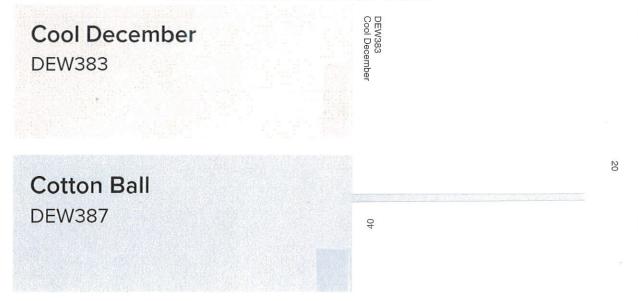

#### 25 YEAR MINIMUM SHINGLES ARCHITECTURAL / DIMENSIONAL STYLE OWENS CORNING OR CERTAINTEED COCOA/GREY



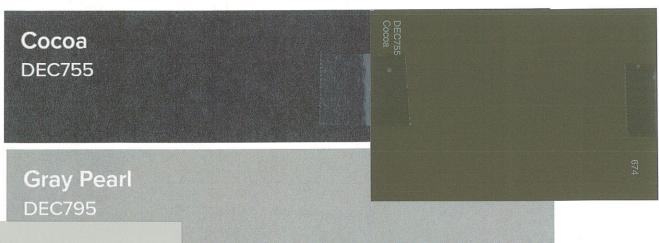

JIANG RESIDENCE - MOSS BEACH

#### BASE ACCENT STONE CULTURED LIMESTONE LIGHT-MEDIUM COLOR REGULAR CUT/SHAPE





JIANG RESIDENCE - MOSS BEACH

#### NPDES NOTES

NOTES MUST BE SHOWN AS WORDED, ON THE TITLE SHEET OF THE PLAN.

1. IN THE CASE OF EMERGENCY, CALL:

1. IN THE CASE OF EMERGE

AT WORK PHONE #
OR CELL PHONE #

2. SEDIMENT FROM AREAS DISTURBED BY CONSTRUCTION SHALL BE RETAINED ON SITE USING STRUCTURAL CONTROLS TO THE MAXIMUM EXTENT PRACTICABLE.

3. STOCKPILES OF SOIL SHALL BE PROPERLY CONTAINED TO MINIMIZE SEDIMENT TRANSPORT FROM THE SITE TO STREETS, DRAINAGE FACILITIES OR ADJACENT PROPERTIES VIA RUNOFF, VEHICLE TACKING, OR WIND.

4. APPROPRIATE BMPS FOR CONSTRUCTION — RELATED MATERIALS, WASTES, SPILLS SHALL BE IMPLEMENTED TO MINIMIZE TRANSPORT FROM THE SITE TO STREETS, DRAINAGE FACILITIES, OR ADJOINING PROPERTIES BY WIND OR RUNOFF.

5. RUNOFF FROM EQUIPMENT AND VEHICLE WASHING SHALL BE CONTAINED AT CONSTRUCTION SITESUNLESS TREATED TO REDUCE OR REMOVE SEDIMENT AND OTHER POLLUTANTS.
6. ALL CONSTRUCTION CONTRACTOR AND SUBCONTRACTOR PERSONNEL ARE TO BE MADE AWARE OR THE REQUIRED BEST MANAGEMENT PRACTICES AND GOOD HOUSEKEEPING MEASURES FOR THE

PROJECT SITE AND ANY ASSOCIATED CONSTRUCTION STAGING AREAS.

7. AT THE END OF EACH DAY OF CONSTRUCTION ACTIVITY ALL CONSTRUCTION DEBRIS AND WASTE MATERIALS SHALL BE COLLECTED AND PROPERLY DISPOSED IN TRASH OR RECYCLE BINS.

8. CONSTRUCTION SITES SHALL BE MAINTAINED IN SUCH A CONDITION THAT AN ANTICIPATED STORM DOES NOT CARRY WASTES OR POLLUTANTS OFF THE SITE. DISCHARGES OF MATERIAL OTHER THAN STORM WATER ONLY WHEN NECESSARY FOR PERFORMANCE AND COMPLETION OF CONSTRUCTION PRACTICES AND WHERE THEY DO NOT: CAUSE OR CONTRIBUTE TO A VIOLATION OF ANY WATER QUALITY STANDARD; CAUSE OR THREATEN TO CAUSE POLLUTION, CONTAMINATION, OR NUISANCE; OR CONTAIN A HAZARDOUS SUBSTANCE IN A QUANTITY REPORTABLE UNDER FEDERAL REGULATIONS

40 CFR PARTS 117 AND 302.

9. POTENTIAL POLLUTANTS INCLUDE BUT ARE NOT LIMITED TO: SOLID OR LIQUID CHEMICAL SPILLS; WASTES FROM PAINTS, STAINS, SEALANTS, GLUES, LIMES, PESTICIDES, HERBICIDES, WOOD PRESERVATIVES AND SOLVENTS; ASBESTOS FIBERS, PAINT FLAKES OR STUCCO FRAGMENTS; FUELS, OILS, LUBRICANTS, AND HYDRAULIC, RADIATOR OR BATTERY FLUIDS; FERTILIZERS, VEHICLE/EQUIPMENT WASH WATER AND CONCRETE WASH WATER; CONCRETE, DETERGENT OR FLOATABLE WASTES; WASTES FROM ANY ENGINE/EQUIPMENT STEAM CLEANING OR CHEMICAL DEGREASING AND SUPER — CHLORINATED POTABLE WATER LINE FLUSHING.

DURING CONSTRUCTION, PERMITTEE SHALL DISPOSE OF SUCH MATERIALS IN A SPECIFIED AND CONTROLLED TEMPORARY AREA ON — SITE, PHYSICALLY SEPARATED FROM POTENTIAL STORM WATER RUNOFF, WITH ULTIMATE DISPOSAL IN ACCORDANCE WITH LOCAL, STATE AND FEDERAL REQUIREMENTS.

10. DE — WATERING OF CONTAMINATED GROUNDWATER, OR DISCHARGING CONTAMINATED SOILS VIA SURFACE EROSION IS PROHIBITED. DE — WATERING OF NON — CONTAMINATED GROUNDWATER REQUIRES A NATIONAL POLLUTANT DISCHARGE ELIMINATION SYSTEM PERMIT FROM THE RESPECTIVE STATE REGIONAL WATER QUALITY CONTROL BOARD.

11. GRADED AREAS ON THE PERMITTED AREA PERIMETER MUST DRAIN AWAY FROM THE FACE OF

SLOPES AT THE CONCLUSION OF EACH WORKING DAY. DRAINAGE IS TO BE DIRECTED TOWARD DE— SILTING FACILITIES.

12. THE PERMITTEE AND CONTRACTOR SHALL BE RESPONSIBLE AND SHALL TAKE NECESSARY PRECAUTIONS TO PREVENT PUBLIC TRESPASS ONTO AREAS WHERE IMPOUNDED WATER CREATES A

**ABBREVIATIONS** 

ABV.

A.F.F.

A.F.S

ALT.

ALU ARCH

BLW.

BLDG.

BLCK.

CLG.

COL.

CONC

CONT.

CPT. C.T.

CTR.

D.S.

DWG(S).

ELEC.

ELEV.

**EQUIP** 

E.W.C.

F.E.C.

F.S.

F.O.C.

F.O.F.

F.O.M.

F.O.S.

F.R.

FUR.

GALV.

G.W.B.

HDR.

H.M.

**HDWR** 

HORZ.

HVAC.

INSUL

INT

G.W.B.-M.R.

G.W.B.-X

EXT.

Air Conditioning

Above Finish Floor

Above Finish Slab

Alternate

Below

Blocking

Ceiling Joist

Control Joint

Center Line

Ceiling

Column

Carpet

Center

Concrete

Continuous

Ceramic Tile

Disabled Access

Drinking Fountain

Drawing

Downspout

Dimension

Existing

Electrical

Elevator

Elevation

Equipment

Forced Air Unit

Fire Extinguisher

Fire Extinguisher

Face of Concrete

Face of Masonry

Face of Finish

Face of Stud

Furring

Fire-Retardant

Gauge or Gage

Galvanized Iron

General Contractor

Gypsum Wall Board

GWB Moisture Resistant

Heating, Ventillation, and

GWB Fire Rated "X"

Galvanized

Hose Bib

Hardware

Horizontal

Insulation

Interior

Hollow Core

Hollow Metal

Air-conditioning

Inside Diameter

Finish Floor

Finish Slab

Cabinet

Floor Drain

Foundation

Exterior

Expansion Joint

Electric Water Cooler

Aluminum

Architect(ural)

Asphaltic Concrete Paving

Lavatory

Laminate

Maximum

Mechanical

Membrane

Minimum

Nominal

Manufacturer

Manufacturer Finish

Masonry Opening

Not in Contract

Not To Scale

On Center

Occupancy

Overhang

Opening

Opposite

Paint

Plaster

Quarry Tile

Refer (to)

Required

Reinforen

Solid Core

Square Foot

Specifications

Stainless Steel

Structural (Engineer)

Top of Beam - Steel

Underwriters Laboratory

Unless Noted Otherwise

Vinyl Composition Tile

Vinyl Wall Covering

Verify in Field

Wrought Iron

Walk in Closet

Water Closet

Water Heater

Water Resistant

Welded Wire Fabric

Window

Top of Concrete

Top of Sheathing

Top of Slab

Top of Wall

Top Plate

Tempered

Typical

Thick

Vertical

Standard

Suspended

Rough Opening

Suspended Acoustical Ceiling

Pair

Outside Diameter

Owner Furnished

Property Line

Pressure Treated

Plywood

Contractor Installe

LAM.

MECH.

**MEMB** 

M.F.

M.O.

NOM

NTS

O.C.

OCC.

O.D.

O.H.

OPNG.

OPP.

O.F.C.I

PLYWD.

**PLAST** 

P.T.

Q.T.

REQD.

REUNF

R.O.

Rm.

S.A.C.

SQ. FT./SF

S.C.

SIM.

SPEC.

S.STL.

SUSP.

T.O.B.

T.O.C.

T.O.S.

T.O.SL.

T.O.W.

**TEMP** 

U.N.O.

VERT.

V.W.C.

W.I.C.

WIN

W.W.F

THK.

T.P.

SHT.

STRUCT

STD.

HAZARDOUS CONDITION.

13. THE PERMITTEE AND CONTRACTOR SHALL INSPECT THE EROSION CONTROL WORK AND INSURE THAT THE WORK IS IN ACCORDANCE WITH THE APPROVED PLANS.

14. THE PERMITTEE SHALL NOTIFY ALL GENERAL CONTRACTORS, SUBCONTRACTORS, MATERIAL SUPPLIERS, LESSEES, AND PROPERTY OWNERS: THAT DUMPING OF CHEMICALS INTO THE STORM DRAIN SYSTEM OR THE WATERSHED IS PROHIBITED.

15. EQUIPMENT AND WORKERS FOR EMERGENCY WORK SHALL BE MADE AVAILABLE AT ALL TIMES DURING THE RAINY SEASON. NECESSARY MATERIALS SHALL BE AVAILABLE ON SITE AND STOCKPILED AT CONVENIENT LOCATIONS TO FACILITATE RAPID CONSTRUCTION OF TEMPORARY DEVICES WHEN RAIN IS IMMINENT.

16. ALL REMOVABLE EROSION PROTECTIVE DEVICES SHALL BE IN PLACE AT THE END OF EACH WORKING DAY WHEN THE 5 — DAY RAIN PROBABILITY FORECAST EXCEEDS 40%.

17. SEDIMENTS FROM AREAS DISTURBED BY CONSTRUCTION SHALL BE RETAINED ON SITE USING AN EFFECTIVE COMBINATION OF EROSION AND SEDIMENT CONTROLS TO THE MAXIMUM EXTENT PRACTICABLE, AND STOCKPILES OF SOIL SHALL BE PROPERLY CONTAINED TO MINIMIZE SEDIMENT TRANSPORT FROM THE SITE TO STREETS, DRAINAGE FACILITIES OR ADJACENT PROPERTIES VIA RUNOFF, VEHICLE TRACKING, OR WIND.

18. APPROPRIATE BMPS FOR CONSTRUCTION — RELATED MATERIALS, WASTES, SPILLS OR RESIDUES SHALL BE IMPLEMENTED AND RETAINED ON SITE TO MINIMIZE TRANSPORT FROM THE SITE TO STREETS, DRAINAGE FACILITIES, OR ADJOINING PROPERTY BY WIND OR RUNOFF.

#### APPLICABLE CODE:

2013 CALIFORNIA BUILDING CODE


2013 CALIFORNIA ELECTRICAL CODE

2013 CALIFORNIA MECHANICAL CODE


2013 CALIFORNIA PLUMBING CODE

2013 CALIFORNIA GREEN BUILDING CODE 2013 T-24 ENERGY CODE

#### VICINITY MAP

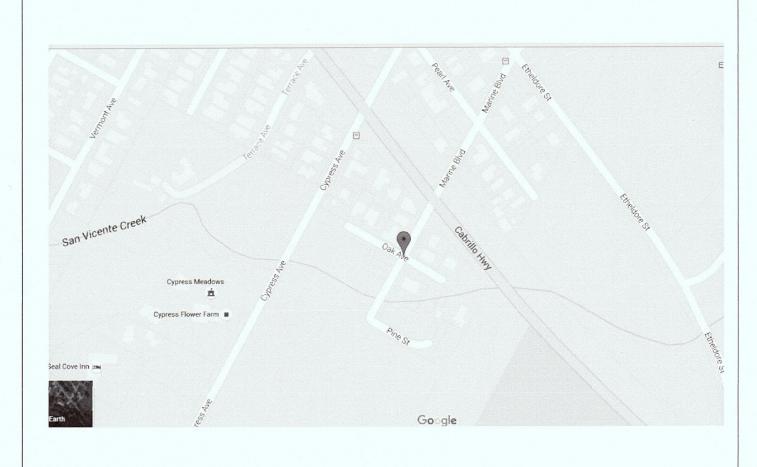

#### JIANG-LIN RESIDENCE - NEW CONSTRUCTION

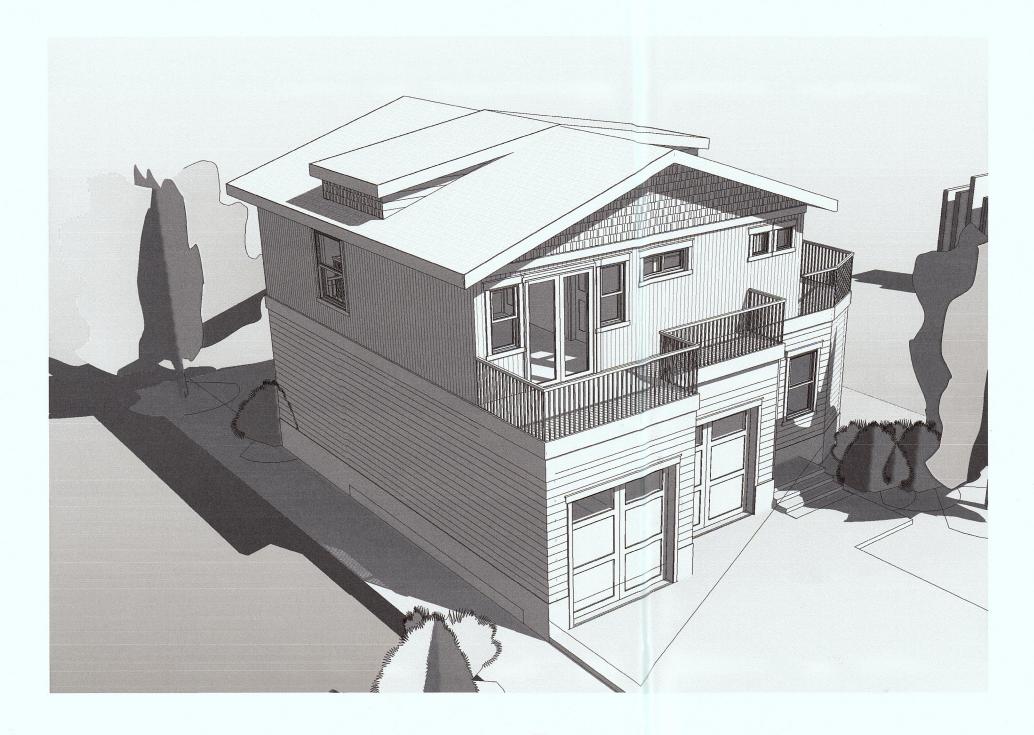

GREEN	<b>BUILDING</b>	CODE	NOTE

1. THE CONSTRUCTION DOCUMENTS SHALL PROVIDE SUFFICIENT CLARIFY TO INDICATE THE LOCATION, NATURE, AND SCOPE OF THE PROPOSED GREEN BUILDING FEATURES. CGBC 102.2

2. PLUMBING FIXTURES AND FITTINGS SHALL MEET THE STANDARDS REFERENCED IN CGBC TABLE 4.303.3. CGBC 4303.3

3. SEAL OPENINGS IN THE BUILDING ENVELOPE IN COMPLIANCE WITH THE CALIFORNIA ENERGY CODE (CEC). AMMLAR SPACES AROUND PIPES, ELECTRIC CABLES, CONDUITS OR OTHER OPENINGS IN PLATES AT EXTERIOR WALLS SHALL BE PROTECTED BY CLOSING SUCH OPENINGS WITH CEMENT MORTAR, CONCRETE MASONRY, OR A SIMILAR METHOD ACCEPTABLE TO THE ENFORCING AGENCY. CGBC 4.406.1

4. REDUCE CONSTRUCTION WASTE BY RECYCLING OR SALVAGING FOR RE-USE A MMLMUM OF 50 PERCENT OF THE NONHAZARDOUS CONSTRUCTION AND DEMOLITION DEBRIS, OR MEET THE LOCAL CONSTRUCTION AND DEMOLITION WASTE MANAGEMENT ORDINANCE, WHICHEVER IS MORE STRINGENT. CGBC 4.408.1

5. CONSTRUCTION WASTE MANAGEMENT PLAN AND DOCUMENTATION DEMONSTRATING COMPLIANCE WITH THE PLAN SHALL BE SUBMITTED THAT:

A. IDENTIFIES THE MATERIALS TO BE DIVERTED FROM DISPOSAL BY RECYCLING, REUSE ON THE PROJECT OR SALVAGE FOR FUTURE USE OR

B. SPECIFIES IF MATERIALS WILL BE SORTED ON-SITE OR MIXED FOR TRANSPORTATION TO A DIVERSION I

C. IDENTIFIES THE DIVERSION FACILITY WHERE THE MATERIAL COLLECTION WILL BE TAKEN.

D. IDENTIFIES CONSTRUCTION METHODS EMPLOYED TO REDUCE THE AMOUNT OF WASTE GENERATED. E. SPECIFIES THAT THE AMOUNT OF MATERIALS

6. AN OPERATION AND MAINTENANCE MANUAL WITH CONTENT PER CGBC 4.410.1 AND IN A FORMAT ACCEPTABLE TO THE ENFORCING AGENCY SHALL BE PLACED IN THE BUILDING AT THE TIME OF FINAL INSPECTION. CGBC 4.410.1. REFER TO HCD RESIDENTIAL GUIDE FOR MANUAL FORMAT AND SUGGESTED CONTENT.

7.GAS FIREPLACES TO BE DIRECT-VENT SEALED-COMBUSTION TYPE. WOODSTOVES OR PELLET STOVES SHALL COMPLY WITH U.S. EPA PHASE II EMISSION LIMITS. CGBC

4.503.1 NOTE: REFERENCE SCAQMD RULE 445.

8. ALL DUCT OPENINGS AND OTHER AIR DISTRIBUTION COMPONENT OPENINGS SHALL BE PROTECTED DURING STORAGE ON THE CONSTRUCTION SITE UNTIL FINAL START-UP WITH TAPE, PLASTIC, SHEET METAL, OR OTHER ACCEPTABLE METHODS TO REDUCE THE AMOUNT OF DUST AND DEBRIS WHICH MAY COLLECT IN THE

9. FINISH MATERIALS SHALL COMPLY WITH CGBC 4.504.2.

10. ADHESIVES, ADHESIVE BONDING PRIMERS, ADHESIVE PRIMERS, SEALANTS, SEALANT PRIMERS, AND CAULKS SHALL COMPLY WITH LOCAL OR REGIONAL AIR POLLUTION CONTROL OR AIR QUALITY MANAGEMENT DISTRICT RULES WHERE APPLICABLE, OR MEET THE REQUIREMENT OF SCAQMD RULE 1168 VOC LIMITS AND

PROHIBITION ON THE USE OF CERTAIN TOXIC CHEMICALS, EXCEPT PER SUBSECTION 2. CGBC 4.504.2.1, SUBSECTION 1

11. AEROSOL ADHESIVES, SMALLER UNIT SIZES OF ADHESIVES, AND SEALANT OR CAULKING COMPOUNDS (IN UNITS OF PRODUCT, LESS PACKING, WHICH DO NOT WEIGH MORE THAN 1 POUND AND DO NOT CONSIST OF MORETHAN 16 FLUID OLMCES SHALL COMPLY WITH STATEWIDE VOC STANDARDS AND OTHER REQUIREMENTS,

WEIGH MORE THAN 1 POUND AND DO NOT CONSIST OF MORETHAN 16 FLUID OLMCES SHALL COMPLY WITH STATEWIDE VOC STANDARDS AND OTHER REQUIRE INCLUDING PROHIBITIONS ON THE USE OF CERTAIN TOXIC COMPOUNDS, OF CCR, TITLE 17, COMMENCING WITH SECTION 94507. 4 CGBC.504.2.1, SUBSECTION 2

12. VOC CONTENT LIMITS FOR ARCHITECTURAL COATINGS (ARCHITECTURAL PAINTS) SHALL COMPLY WITH CGBC TABLE 4.504.3.

13. AEROSOL PAINTS AND COATINGS SHALL MEET THE REQUIFEMENTS OF SECTIONS 94522(A)(3), 94522(C)(2), AND (D)(2) OF CALIFORNIA CODE OF REGULATIONS, TITLE 17 COMMENCING WITH SECTION 94520. CGBC 4.504.2.3

14. VERIFICATION OF COMPLIANCE WITH FINISH MATERIALS SHALL BE PROVIDED AT THE REQUEST OF THE ENFORCING AGENCY. DOCUMENTS MAY INCLUDE, BUT NOT LIMITED TO THE FOLLOWING:

A. MANUFACTURER'S PRODUCT SPECIFICATION.

B. FIELD VERIFICATION OF ON-SITE PRODUCT CONTAINERS.
C. OTHER METHODS APPROVED BY THE LOCAL JURISDICTION.

15. CARPETS SHALL MEET ONE OF THE FOLLOWING: 1. CARPETAND RUG INSTITUTE'S GREEN LABEL PLUS PROGRAM, 2. CALIFORNIA DEPARTMENT OF PUBLIC HEALTH STANDARD PRACTICE FOR THE TESTING OFVOCS (SPECIFICATON 01350), 3. NSF/ANSI 140 AT THE GOLD LEVEL. 4. SCIENTIFIC CERTIFICATIONS SYSTEMS INDOOR ADVANTAGETM GOLD. CGBC 4.504.3

16. CARPET CUSHION SHALL MEET THE REQUIREMENTS OF THE CARPET AND RUG INSTITUTE GREEN LABEL PROGRAM, CARPET ADHESIVE SHALL MEET THE REQUIREMENTS OF CGBC TABLE 4.504.1. CGBC 4.504.3.1, 4.504.3.2

17. FOR RESILIENT FLOORING, AT LEAST 50 PERCENT OF THE FLOOR AREA SHALL COMPLY WITH VOC EMISSION LIMITS DEFINED IN THE COLLABORATIVE FOR HIGH PERFORMANCE SCHOOLS (CI-IPS) LOW-EMITTING MATERIALS LIST OR CERTIFIED UNDER THE RESILIENT FLOOR COVERING INSTITUTE (RFCI) FLOORSCORE PROGRAM. CGBC 4.504.4

18. HARDWOOD PLYWOOD, PARTICLEBOARD, AND MEDIUM DENSITY FIBERBOARD COMPOSITE WOOD PRODUCTS SHALL MEET THE REQUIREMENTS FOR FORMALDEHYDE LIMITS IN CGBC TABLE 4.504.5. CGBC 4.504.5

19. DOCUMENTATION SHALL BE PROVIDED TO INDICATE COMPLIANCE WITH CGBC 4.504 AND SHALL INCLUDE AT LEAST ONE OF THE FOLLOWING: PRODUCT CERTIFICATIONS AND SPECIFICATIONS, CHAIN OF CUSTODY CERTIFICATIONS, OR OTHER METHODS ACCEPTABLE TO THE ENFORCING AGENCY. CGBC 4.504.5.1

PROVIDE A CAPILLARY BREAK INSTALLED IN. COMPLIANCE WITH ONE OF THE FOLLOWING:

A. A 4-INCH THICK BASE OF 1/2-INCH OR LARGER CLEAN AGGREGATE, WITH A

VAPOR BARRIER IN DIRECT CONTACT WITH CONCRETE, AND A CONCRETE

20. CONCRETE SLAB FOUNDATIONS REQUIRED TO HAVE A VAPOR RETARDER BY CBC, CCR TITLE 24, PART 2, CHAPTER 19 SHALL ALSO COMPLY WITH THIS SECTION.

MIX DESIGN WHICH WILL ADDRESS BLEEDING, SHRINKAGE, AND CURLING.
B. OTHER EQUIVALENT METHODS APPROVED BY THE ENFORCING AGENCY.
C. A SLAB DESIGN SPECIFIED BY A LICENSED DESIGN PROFESSIONAL. CGBC D. REFERENCE ACI 302.

21. ADD A NOTE TO PLANS THE BUILDING MATERIALS WITB VISIBLE SIGNS OF WATER DAMAGE SHALL NOT BE INSTALLED. CGBC 4.505.3

22. MOISTURE CONTENT OF BUILDING MATERIALS, AND VERIFICATION, SHALL MEET THE REQUIREMENTS OF CGBC 4.505.3.

23. BATHROOM EXHAUST FANS SHALL BE ENERGY STAR COMPLIANT, DUCTED TO TERMINATE OUTSIDE THE BUILDING, AND CONTROLLED BY A HUMIDSTAT CAPABLE OF BEING ADJUSTED BETWEEN THE RELATIVE HUMIDITY RANGE OF 50 TO 80 PERCENT. CGBC 4.506

4.505.2.1

24. COVERS FOR WHOLE HOUSE EXHAUST FANS SHALL HAVE A MINIMUM INSULATION VALUE OFR-4.2 AND CLOSE WHEN THE FAN IS OFF. CGBC 4.507.

OWNER:

JIANG-LIN 0 MARINE BLVD. MOSS BEACH, CA

MODULAR MANUFACTURER
CUTTING EGDE HOMES
270 E DOUGLAS AVE.
EL CAJON, CA 92020

310-867-3993

	Sheet Name	Sheet Number
	Titile Sheet	A0
3	Site Plan	A1
	Floor Plans	A2
	Roof Plan	A3
	Elevations	A4
	Elevations	A4.1
	Building Section	A5
	3D View	A6
	Window Schedule	A7

**Sheet List** 

#### SCOPE

NEW CONSTRUCTION FOR MODULAR HOME

PROJECT DATA:

BUILDING(S) OCCUPANCY: R-1

ZONE: R1/S17/DR
CONSTRUCT TYPE: V-B

STORIES:

<ul> <li>SQUARE FOOTAGE BREAKDOWN</li> </ul>		
Name	Area	
POSED FIRST DR	626 SF	

PROPOSED FIRST FLOOR	626 SF
PROPOSED SECOND FLOOR	713 SF
SITE BUILT DECK	109 SF
SITE BUILT GARAGE	485 SF
SITE BUILT PORCH	24 SF
SITE BUILT DECK	222 SF

#### PARCEL COVERAGE

1136 (HOUSE + GARAGE) / 3800 (LOT SIZE) X 100 = 30%

PARCEL COVERAGE = BUILDINGS, ACCESSORY BUILDING, OR STRUCTURES SUCH AS PATIOS DECKS, BALCONIES & OTHER SIMILAR OVER 18" ABOVE GROUND

BUILDING FLOOR AREA

HOUSE 1ST FLR (626 SF) + HOUSE 2ND FLR (713 SF)+ SITE BUILT GARAGE (485 SF) =

 $1824 \text{ SF} / 3800 = 0.48 \qquad (MAX \ 0.48)$ 

APN:037-186-210



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# RESIDENCE O MARINE BLVD.


No.	Description	Date
Α	PRELIMINARY DESIGN	2015.09.16
В	REVISED DRAWINGS	2015.10.03
С	PLANNING SUBMITTAL	2015.12.31
D	PLANNING CHANGES	2016.05.23
		3

#### LIN & JIANG RESIDENCE 2 STORY HOME Titile Sheet

Project number	15-1715
Date	2015-09-16
Drawn by	Author
Checked by	Checker

**A0** 

ale

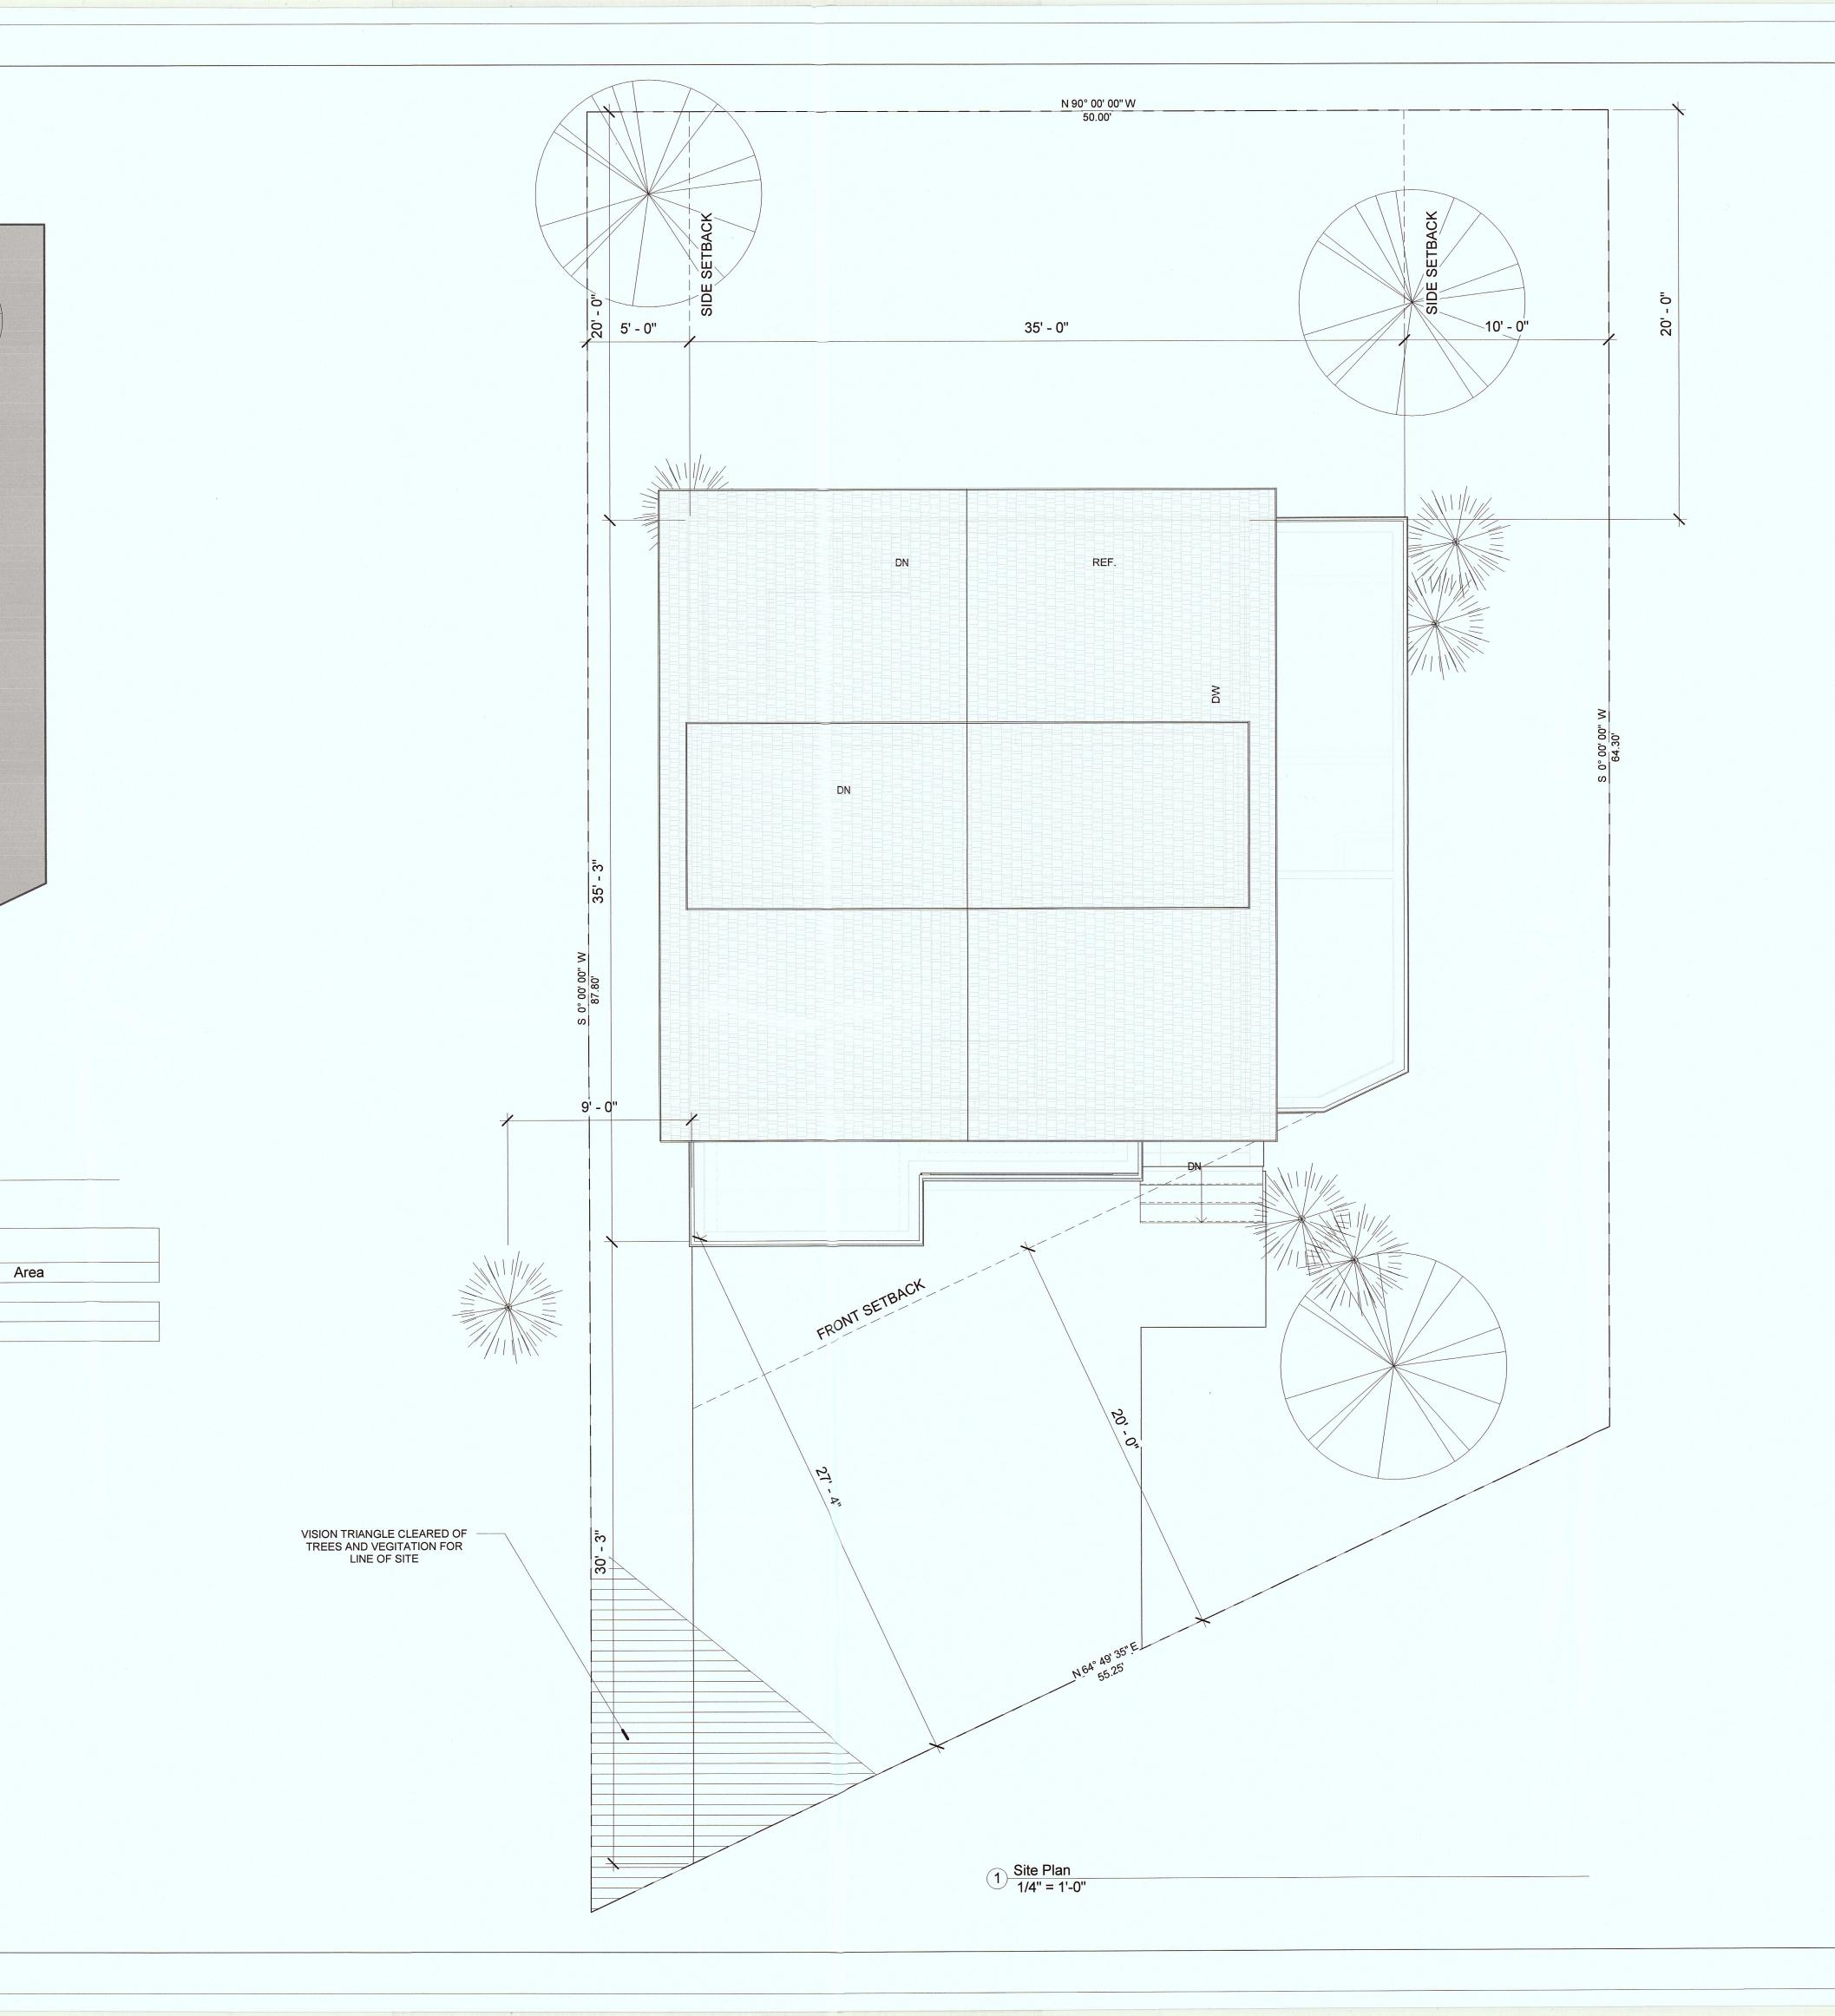

HOUSE FOOT PRINT

1136 SF

OPEN AREA 2667 SF

Area Schedule

1136 SF 2667 SF

3803 SF

Name

2 GRADE 1/8" = 1'-0"

HOUSE FOOT PRINT

OPEN AREA





No.	Description	Date
Α	PRELIMINARY DESIGN	2015.09.16
В	REVISED DRAWINGS	2015.10.03
С	PLANNING SUBMITTAL	2015.12.3
D	PLANNING CHANGES	2016.05.23

LIN & JIANG RESIDENCE 2 STORY HOME Site Plan

Checked by	Checker
Drawn by	Author
Date	2015-09-16
Project number	15-1715

As indicated

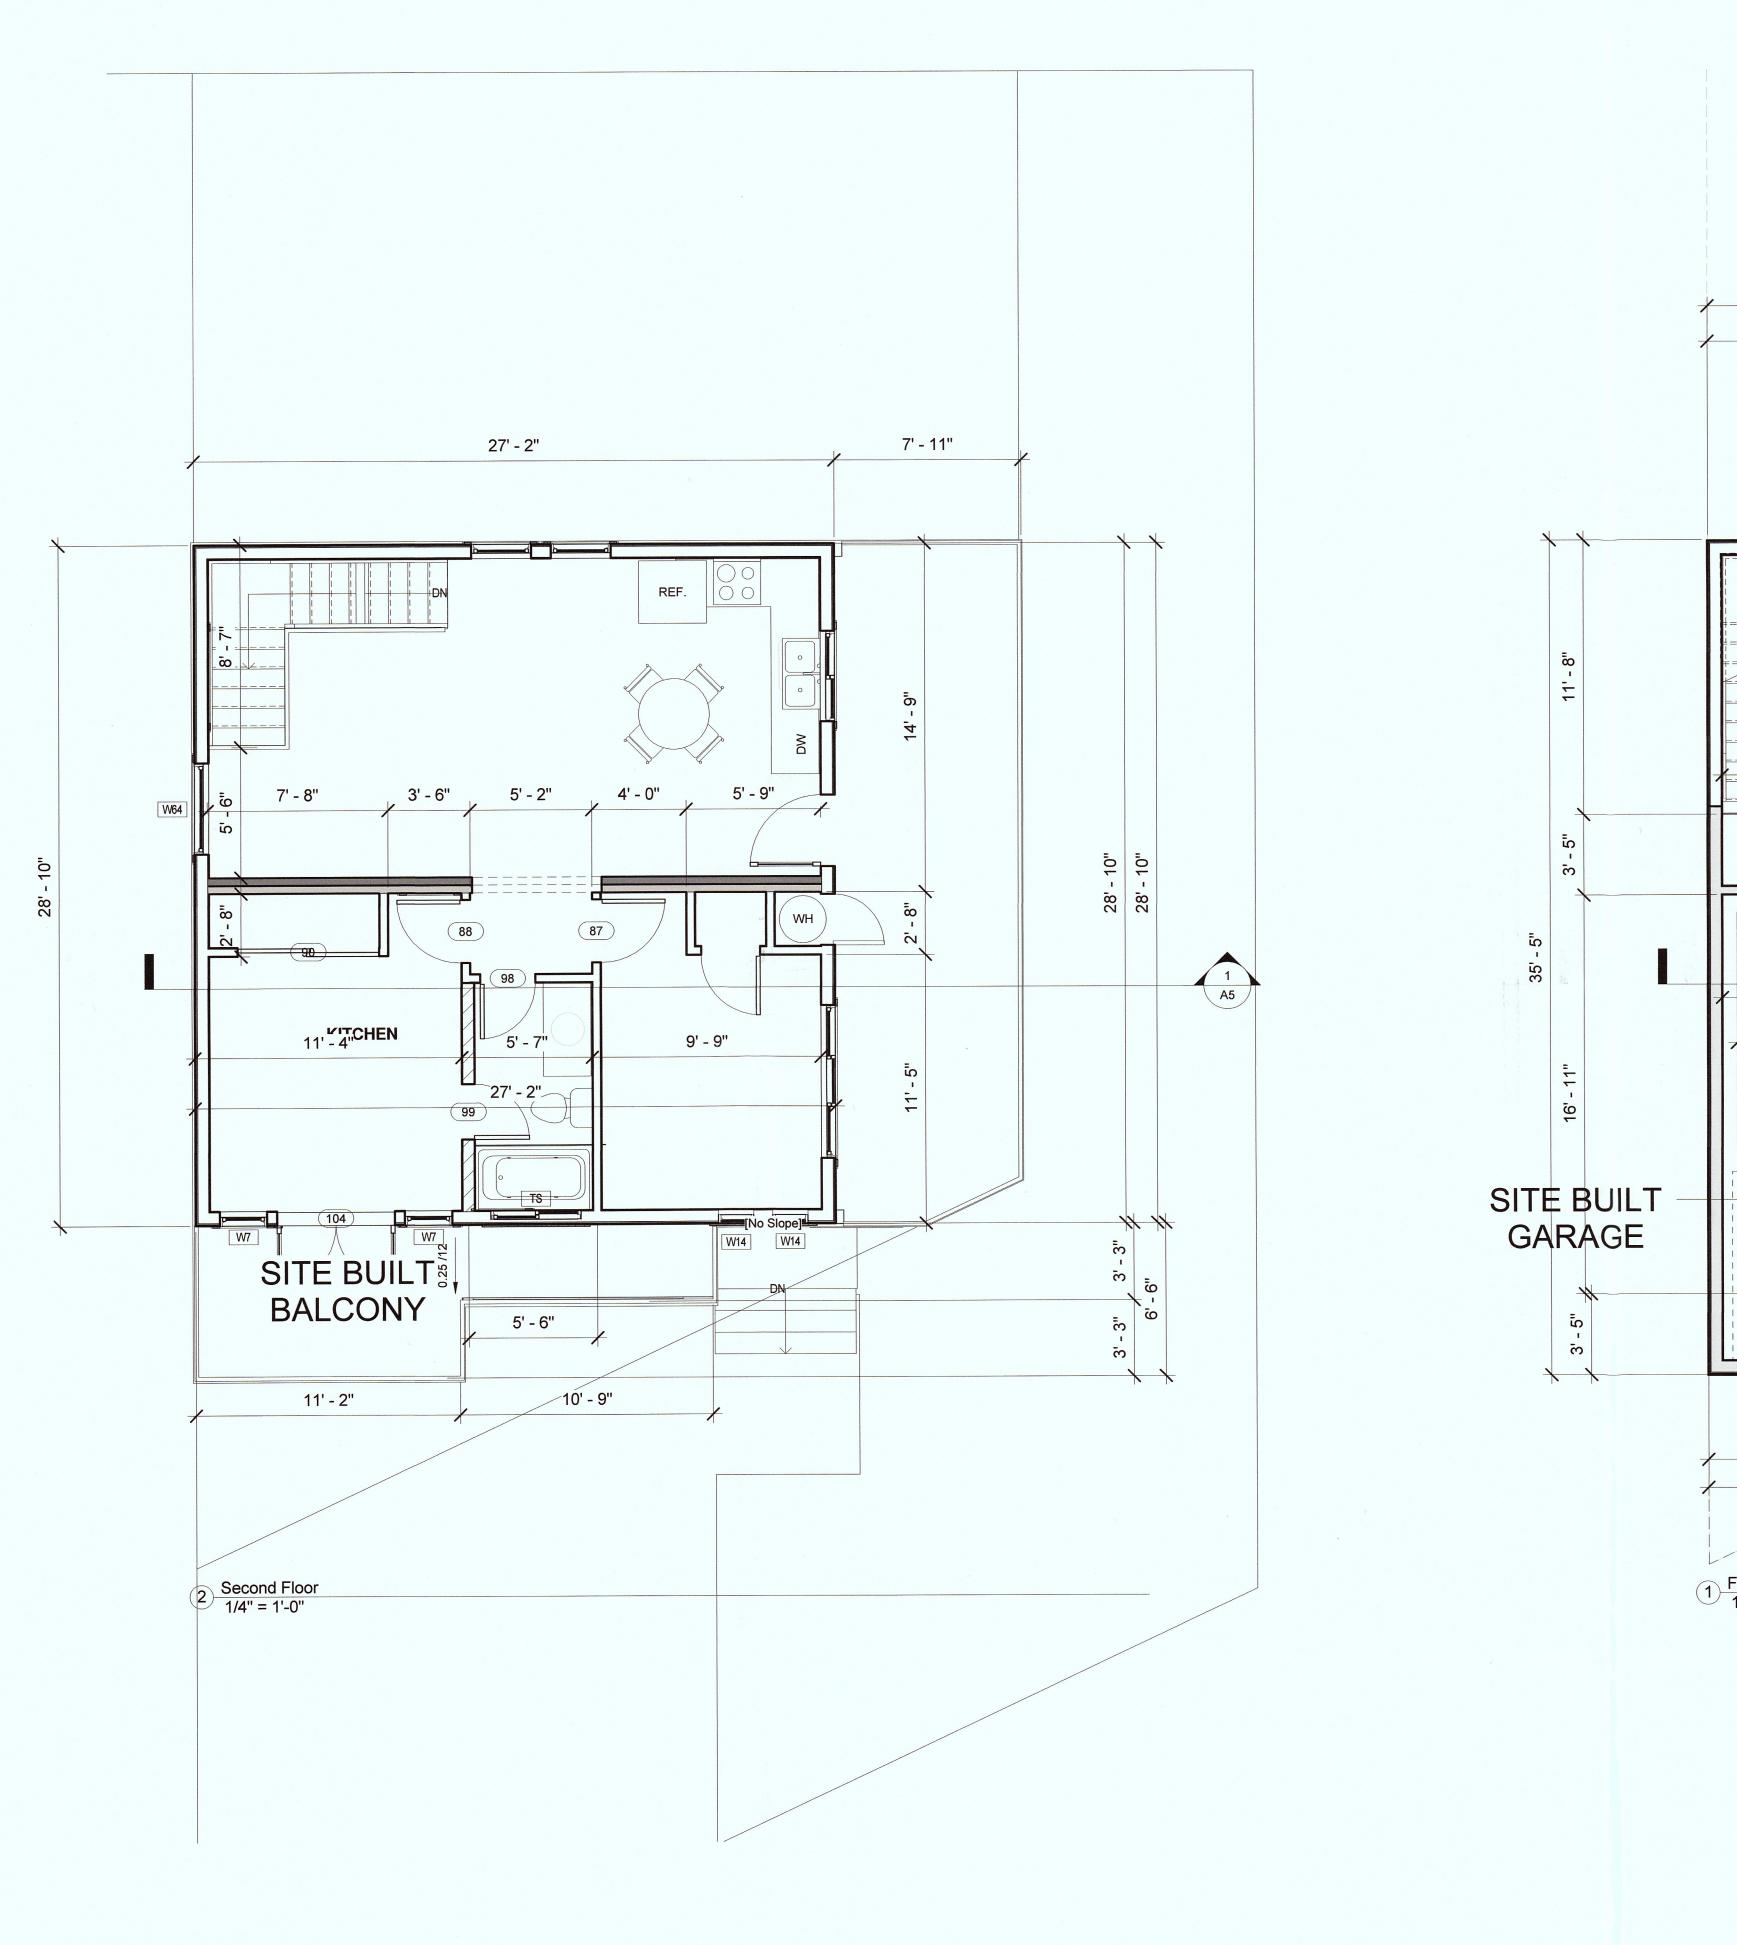

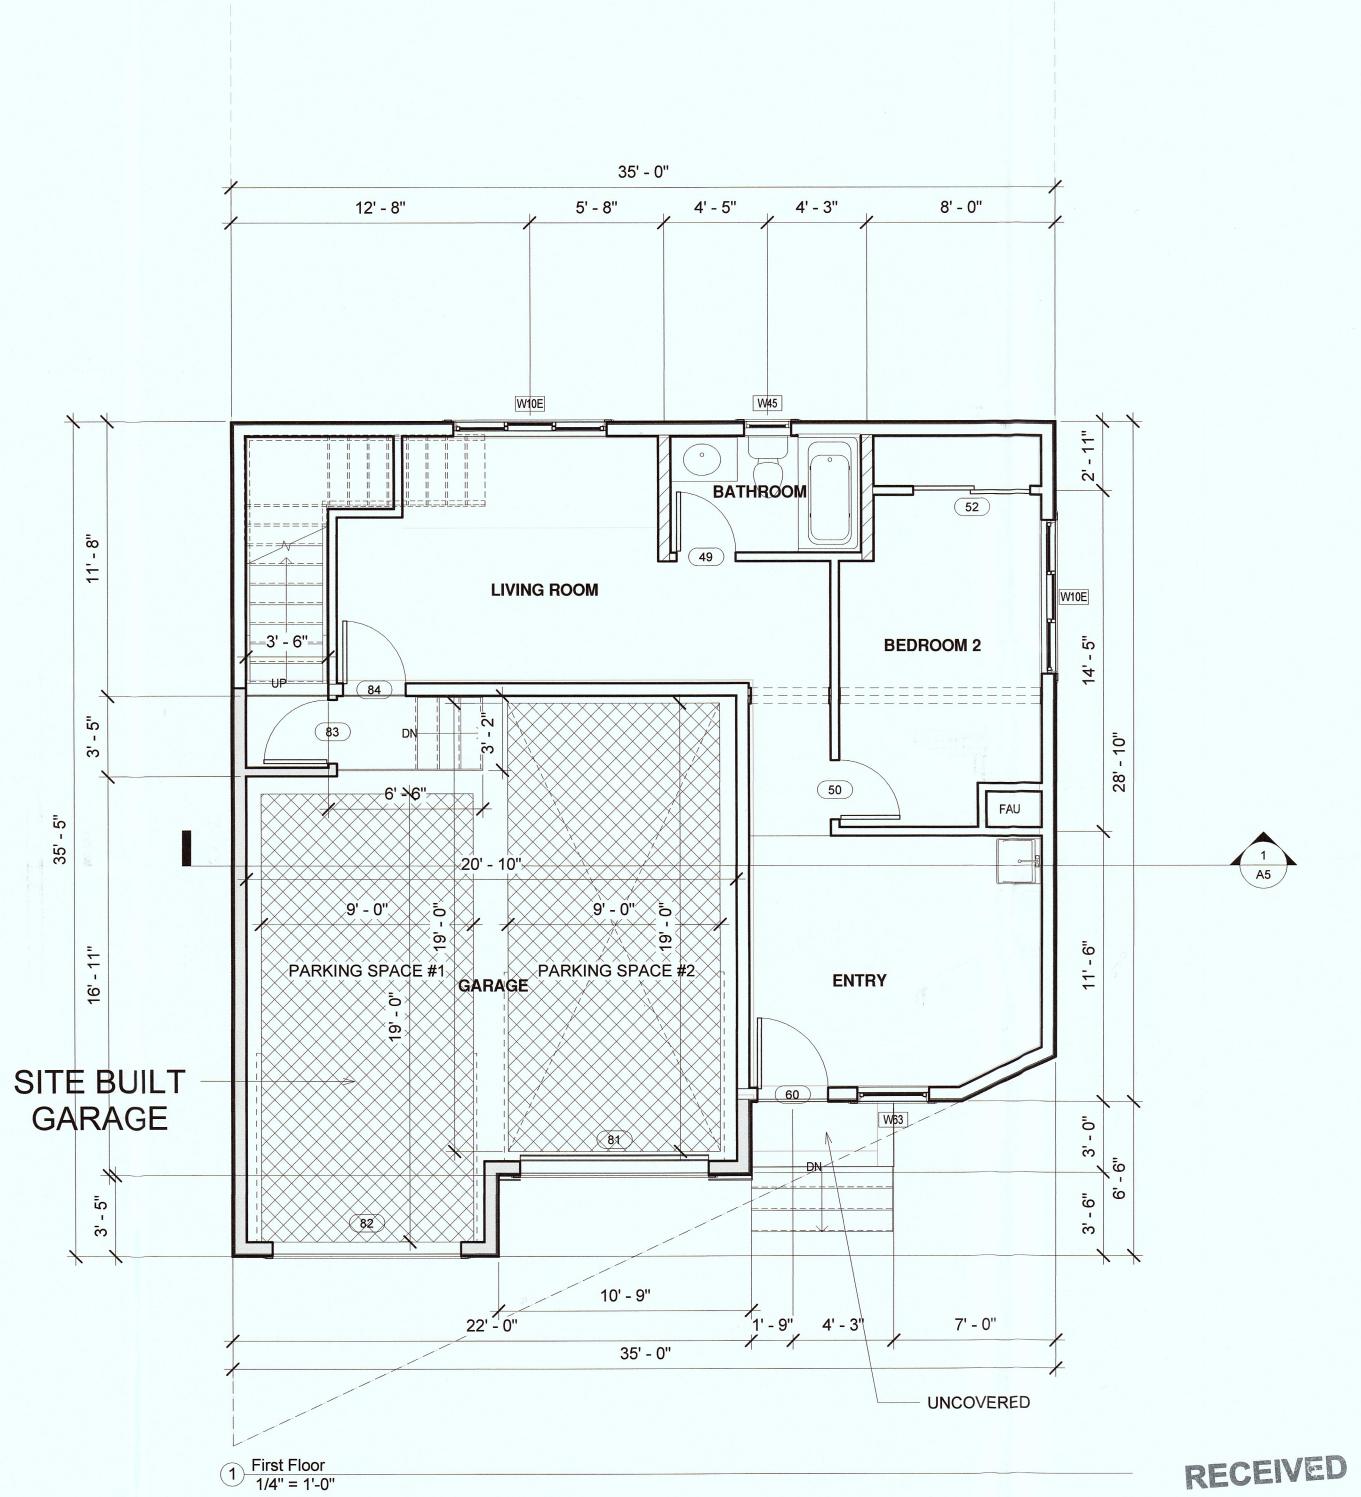



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Α	PRELIMINARY DESIGN	2015.09.1
В	REVISED DRAWINGS	2015.10.0
С	PLANNING SUBMITTAL	2015.12.3
D	PLANNING CHANGES	2016.05.2
Е	PLANNING CHANGES	2016.12.2
		De.
		1.0
		1

LIN & JIANG RESIDENCE 2 STORY HOME Floor Plans

Project number	15-1715
Date	2015-09-16
Drawn by	Author
Checked by	Checker
	^

**A2**1/4" = 1'-0"

Scale

PUN2016-DU129

**RAILING** 

HALF WALL INTERIOR

**WALL LEGEND** 

DEC 29 2016

San Mateo County
Planning and Building Department

STANDARD 2 X 6 EXTERIOR WALL


INTERIOR 2 X 6 PLUMBING WALL

STRUCTURAL INTERIOR WALL

NON STRUCTURAL INTERIOR WALL

SITE BUILT 2 X 6 WALL

0"

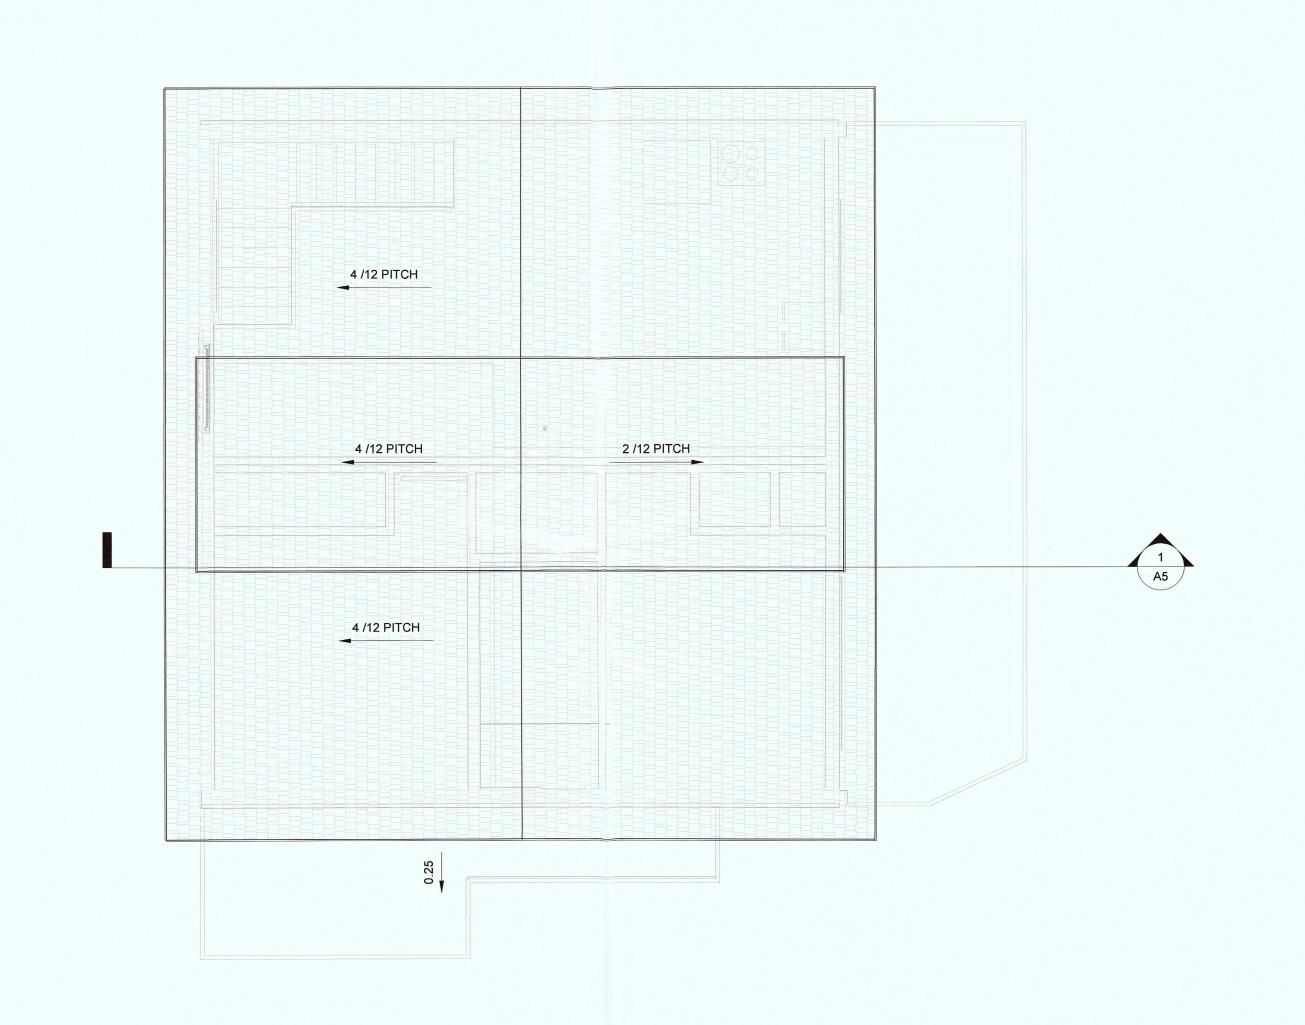

1 Roof Plan 1/4" = 1'-0"



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No.	Description	Date
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В	REVISED DRAWINGS	2015.10.03
С	PLANNING SUBMITTAL	2015.12.3
D	PLANNING CHANGES	2016.05.23

LIN & JIANG RESIDENCE 2 STORY HOME Roof Plan

Project number	15-171
Date	2015-09-1
Drawn by	Autho
Checked by	Checke

**A**3

1/4" = 1'-0"



#### **Materials Legend**



STONE - LIMESTONE RUSTIC (OR SIMILAR)



30 YEAR COMP SHINGLE BY **OWENS CORNING** 



TYPE: DRIFTWOOD




FIBER CEMENT HORIZONTAL WALL SIDING

COLOR: EUCALYPTUS TREE




FIBER CEMENT BOARD & BATTEN



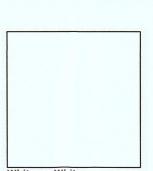


WINDOW TRIM: 5/4 FASCIA BOARD: 7.5" MIN.

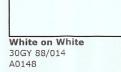

COLOR: WHITE ON WHITE



SHINGLES AT GABLES COLOR: WHITE SHAKE

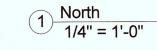

PLANNING REQUIREMENTS:

28'-0"

MAX HEIGHT: MAX PARCEL COVERAGE:

16'-0" + 35%



Date 2015.09.16 2015.10.03 2015.12.31 2016.05.23 PRELIMINARY DESIGN PLANNING SUBMITTAL PLANNING CHANGES

S Homes

THESE CONSTRUCTION DOCUMENTS CREATED BY CUTTING

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94038

LIN & JIANG RESIDENCE 2 STORY HOME

Elevations

15-1715 2015-09-16 E.D.S Checked by

1/4" = 1'-0"

2 South 1/4" = 1'-0"

## T.O. Roof 2 27' - 1 1/2" Roof 20' - 5" Second Floor 12' - 5" T.O.P. 1ST 10' - 5" 13' - 5" First Floor 1' - 5" GRADE 0' - 0"

#### **Materials Legend**



STONE - LIMESTONE RUSTIC (OR SIMILAR)



30 YEAR COMP SHINGLE BY **OWENS CORNING** 




TYPE: DRIFTWOOD




FIBER CEMENT HORIZONTAL WALL SIDING

COLOR: EUCALYPTUS TREE

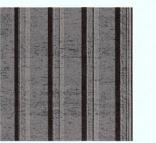


FIBER CEMENT BOARD & BATTEN COLOR: EUCALYPTUS TREE

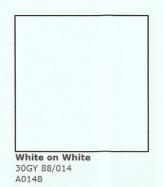


WINDOW TRIM : 5/4 FASCIA BOARD: 7.5" MIN. COLOR: WHITE ON WHITE



SHINGLES AT GABLES COLOR: WHITE SHAKE

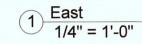

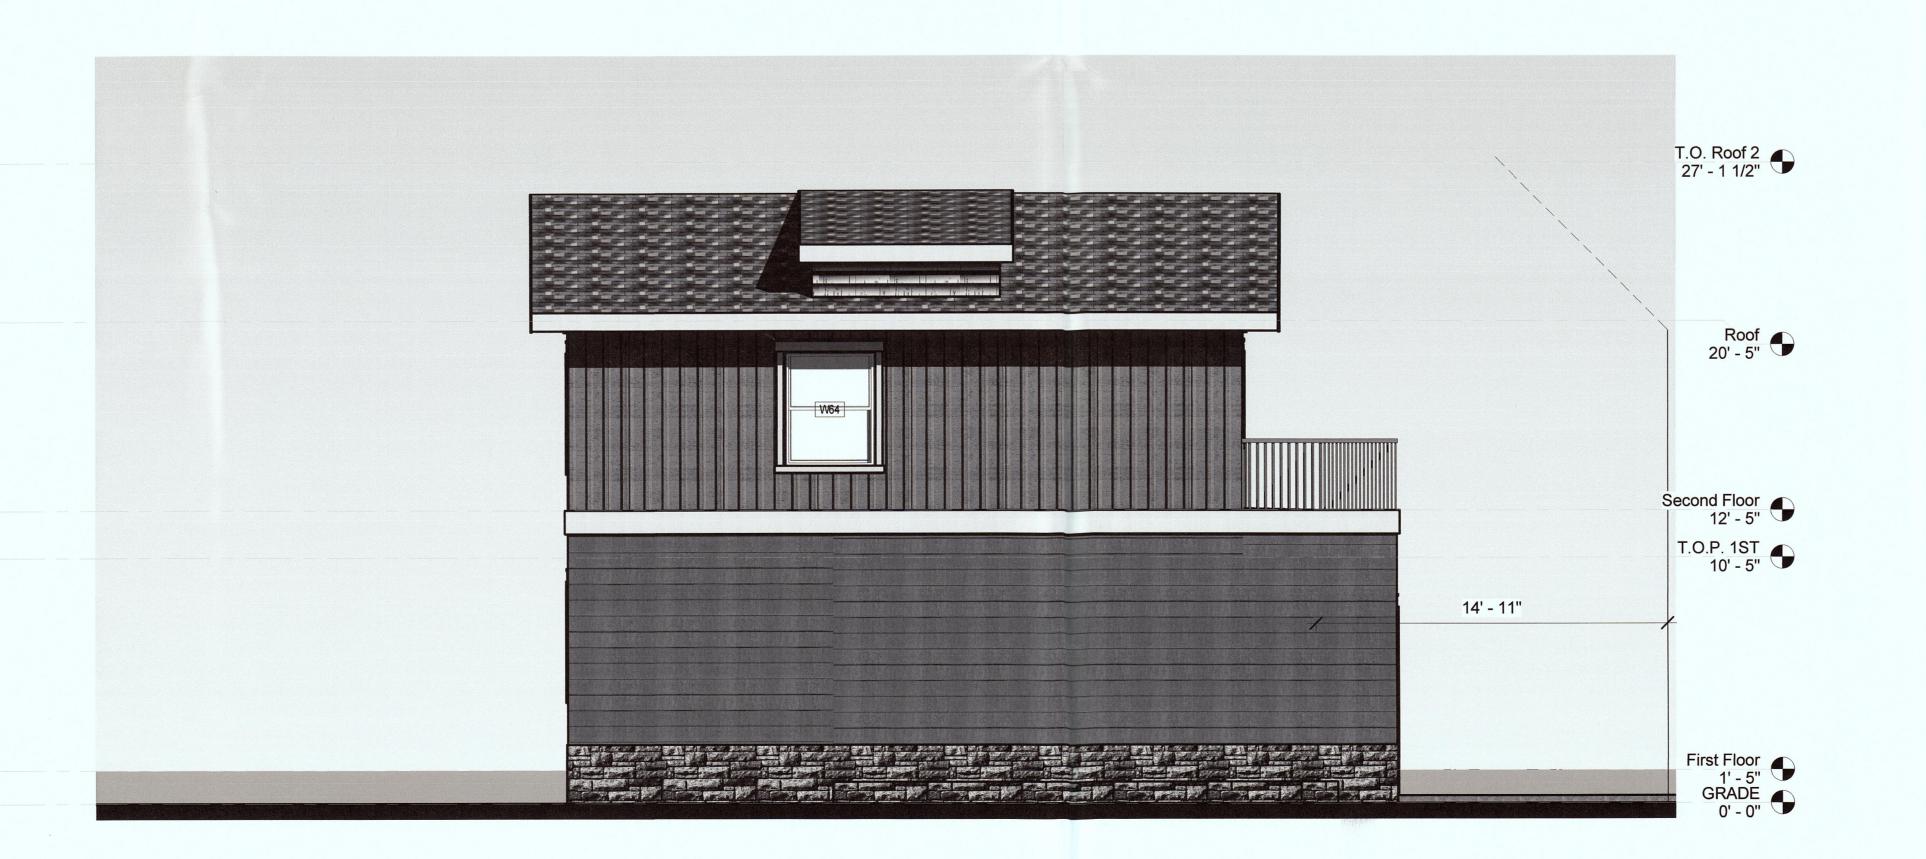

# MARINE BEACH

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E S

Homes

Avenue
92020
993

Cutting Edge I

No.	Description	Date
Α	PRELIMINARY DESIGN	2015.0
В	REVISED DRAWINGS	2015.1
С	PLANNING SUBMITTAL	2015.1
D	PLANNING CHANGES	2016.0
	*	
July 1		


**LIN & JIANG** RESIDENCE 2 STORY HOME Elevations

1		
	Project number	15-1715
	Date	2015-09-16
	Drawn by	Author
	Checked by	Checker

A4.1

1/4" = 1'-0"

2 West 1/4" = 1'-0"

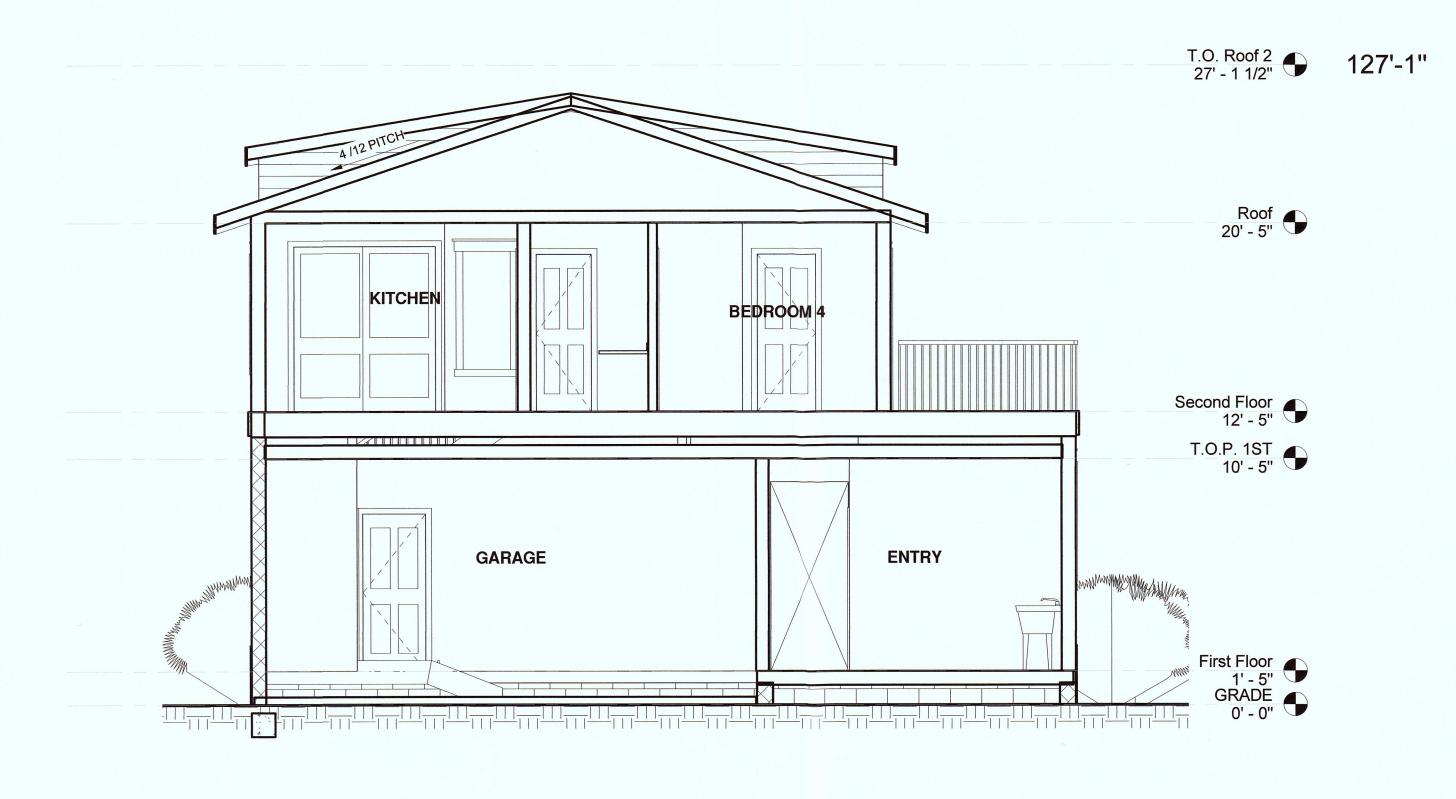

1 Section 1 1/4" = 1'-0"

RESIDENCE

0 MARINE BLVD.

MOSS BEACH, CA 94038

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HOMES

Cutting Edge Homes

270 E Douglas Avenue
El Cajon,, CA 92020
310 867 3993

 No.
 Description
 Date

 A
 PRELIMINARY DESIGN
 2015.09.16

 B
 REVISED DRAWINGS
 2015.10.03

 C
 PLANNING SUBMITTAL
 2015.12.31

 D
 PLANNING CHANGES
 2016.05.23

LIN & JIANG RESIDENCE 2 STORY HOME Building Section


Project number	15-1715
Date	2015-09-16
Drawn by	Author
Checked by	Checker

A5


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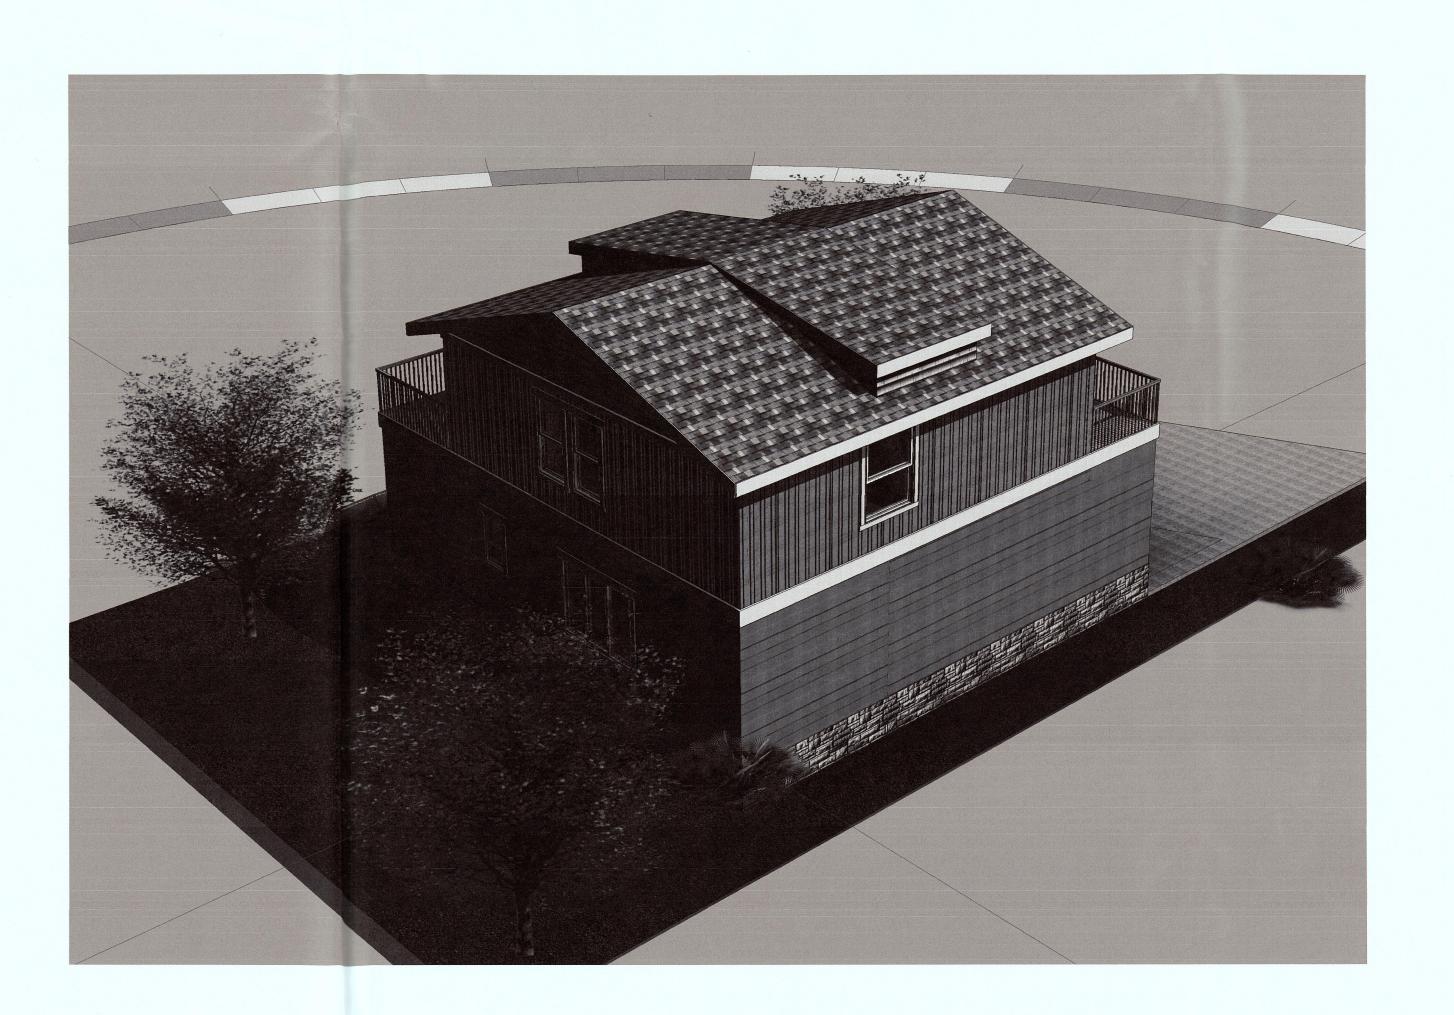
1/4" = 1'-0"

1/2016 10:34:32 PM



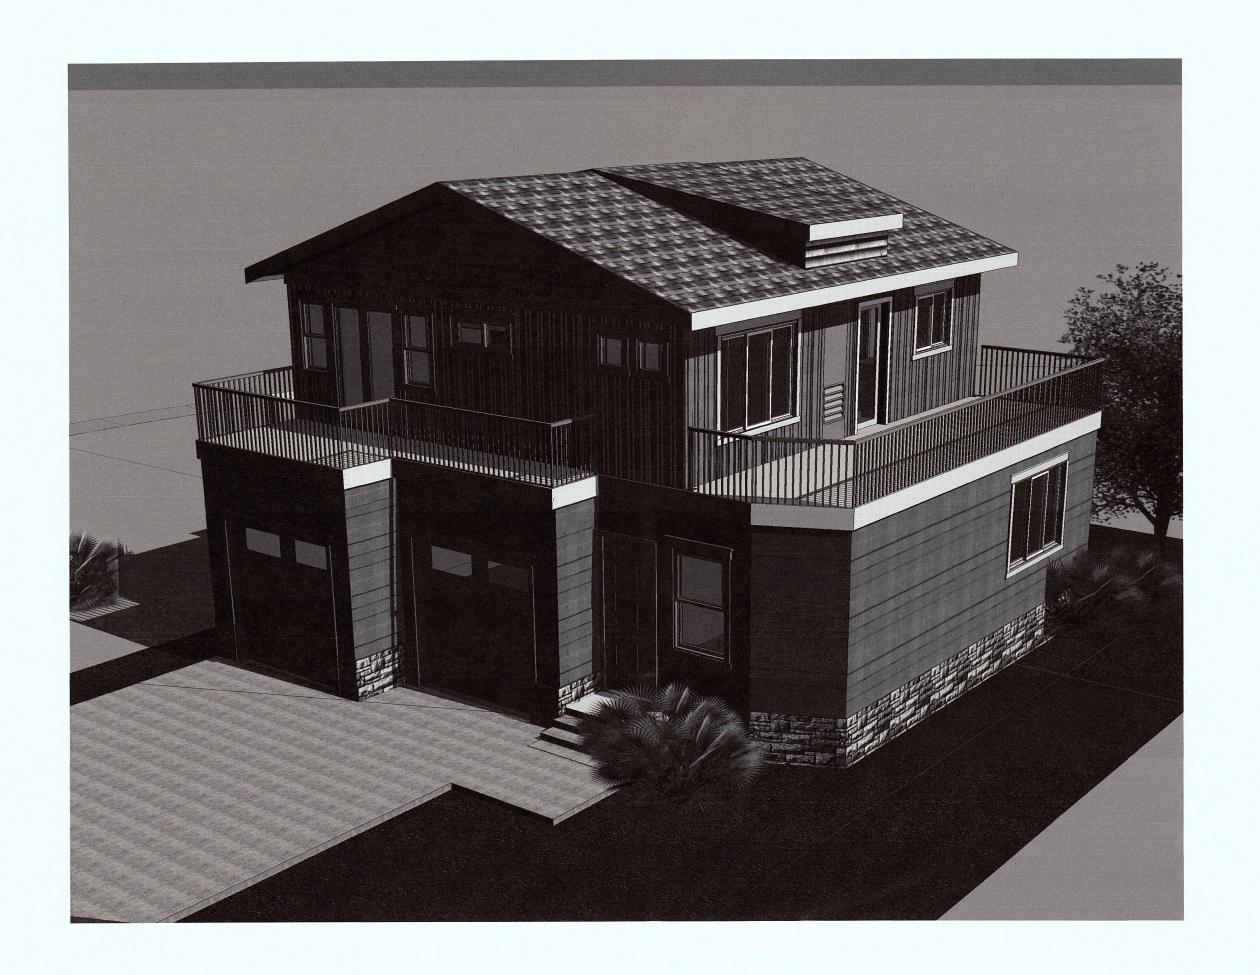



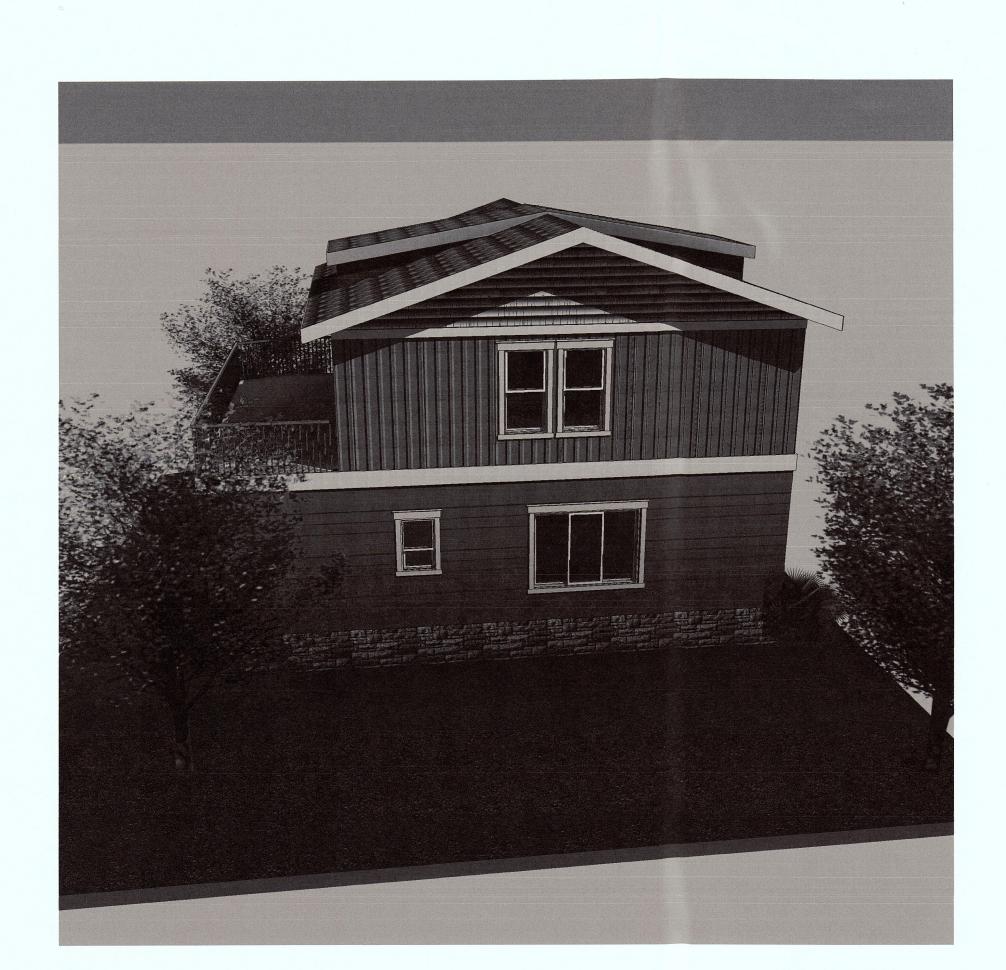

# LIN & JIANG RESIDENCE

No.	Description	Date
Α	PRELIMINARY DESIGN	2015.09
В	REVISED DRAWINGS	2015.10
С	PLANNING SUBMITTAL	2015.12.
D	PLANNING CHANGES	2016.05.

#### LIN & JIANG RESIDENCE 2 STORY HOME

3D View

15-171
2015-09-16
Autho
Checke

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4/23/2016

WINDOW					SQ. FT.	SQ. FT.	SQ. FT.	SQ. FT.	SQ. FT.
NUMBER	CALL OUT		ROUGH OPENING	DESCRIPTION	LIGHT	VENT	R.O.	LT. AREA	VT. AREA
W- 5	40 x 38 H		40 1/2 x 38 1/2	H.S.	8.01	4.33	10.83	100.13	108.2
W- 8	96 x 39 H		96 1/2 x 40	H.S. XOX	21.26	11.19	26.81	265.75	279.7
W- 9E	96 x 58 H		96 1/2 x 59	H.S. XOX	31.85	16.18	39.54	398.13	404.5
W-10E	78 x 58 H		78 1/2 x 59	H.S. XOX	26.01	15.37	32.16	325.13	384.2
W-12	46 x 10 H		46 1/2 x 10 1/4	H.S.	1.57	1.25	3.23	19.63	31.2
W-16	24 x 27 H		24 1/2 x 27 1/4	H.S. OBS	2.83	1.61	4.63	35.38	40.2
W-17	46 x 48 H OBS		46 1/2 x 48 1/4	H.S. (SAFETY) OBS	12.12	6.46	15.54	151.50	161.50
W-19	46 x 48 H		46 1/2 x 48 1/4	H.S. (SAFETY)	12.12	6.46	15.54	151.50	161.50
W-20	24 x 80 V		24 1/2 x 80 1/2	PARTIAL FIXED 1/4 VENT	10.17	3.98	13.70	127.13	99.50
W-21E	36 x 80 V	(mulled)	36 1/2 x 80 1/2	PARTIAL FIXED 1/4 VENT	16.10	6.19	20.40	201.25	154.75
W-22E	46 x 80 V	(mulled)	46 1/2 x 80 1/2	PARTIAL FIXED 1/4 VENT	21.04	8.04	25.99	263.00	201.00
W-24	46 x 52 VS		46 1/2 x 52 1/2	PARTL FIXED 1/4 VENT(SAFETY)	12.91	3.42	16.95	161.375	85.5
W-25	36 x 52 V		36 1/2 x 52 1/2	PARTIAL FIXED 1/4 VENT	9.9	2.63	13.31	123.75	65.75
W-28E	30 x 80 V	(mulled)	30 1/2 x 80 1/2	V.S. 1/2 VENT	13.14	5.11	17.05	164.25	127.7
W-32E	46 x 39 H		46 1/2 x 40	H.S.	9.82	5.27	12.92	122.75	131.75
W-33	46 x 39 H OBS		46 1/2 x 40	H.S. (SAFETY) OBS	9.82	5.27	12.92	122.75	131.79
W-34	46 x 39 H		46 1/2 x 40	H.S. (SAFETY)	9.82	5.27	12.92	122.75	131.75
W-35E	30 x 58 V		30 1/2 x 59	V.S. 1/2 VENT	9.48	5.08	12.5	118.5	12
W-36	46 x 39 P OBS		46 1/2 x 40	P.W. (SAFETY)	9.82	5.27	12.92	122.75	131.7
W-37			24 1/2 x 58 7/8	V.S.	7.31	3.98	10.01	91.375	99.
W-38			14 1/2 x 58 7/8	V.S.	3.7	2.13	5.93	46.25	53.25
W-45	24 x 39 V		24 1/2 x 40	V.S.	4.65	2.41	6.8	58.125	60.25
W-47			21 1/2 x 59	V.S.	6.23	3.42	8.81	77.875	85.5
W-60			54 1/2 x 27 1/4	H.S.	7.65	4.08	10.31	95.625	103
W-61			30 1/2 x 27 1/4	H.S.	3.81	2.07	5.77	47.625	51.75
W-63E	36 x 58 V		36 1/2 x 59	V.S. 1/2 VENT	11.65	6.19	14.95	145.625	154.7
W-64E	46 x 58 V		46 1/2 x 59	V.S. 1/2 VENT	15.27	8.04	19.05	190.875	20:
W-72	30 x 39 V		30 1/2 x 40	V.S. 1/2 VENT	6.03	3.08	8.47	75.38	77.0
W-73	30 x 36 V		30 1/2 x 36 1/4	V.S. 1/2 VENT	5.37	2.73	7.60	67.13	68.2
W-75	24 x 54 VS		24 1/2 x 54 1/2	V.S. VENT (SAFETY)	6.60	3.32	9.27	82.50	83.0
W-76	14 x 39 VO		14 1/2 x 40	V.S. VENT OBS	2.35	1.29	4.02	29.38	32.2
W-79	24 x 54 V		24 1/2 x 54 1/2	V.S. VENT OBS (SAFETY)	6.60	3.32	9.27	82.50	83.0
W-91	30 x 27 V		30 1/2 x 27 1/4	V.S. 1/2 VENT	3.73	2.06	5.77	46.625	51.


CuttingEdgeHomes.Net

Revised:

4/23/2016

WINDOW			A.S	SQ. FT.	SQ. FT.	SQ. FT.	SQ. FT.	SQ. FT.
NUMBER	CALL OUT	ROUGH OPENING	DESCRIPTION	LIGHT	VENT	R.O.	LT. AREA	VT. AREA
W-13	46 x 10 P	46 1/2 x 10 1/4	FIXED	2.23	0	3.23	27.875	
W-14*	18 x 18 BLOCK	17 5/8 x 17 5/8	18" SQUARE ACRILIC BLOCK	1.77	.0	2.16	22.125	
W-15*	48 x 48 BLOCK	48 1/4 X 48 1/4	48" SQUARE ACRILIC BLOCK	14.69	0	16.17	183.625	
W-23	36 x 10 P	36 1/2 x 10 1/4	FIXED	1.72	0	2.53	21.5	
W-26	12 x 72 P	12 1/2 x 72 1/4	FIXED (SAFETY)	4.64	0	6	58	
W-29	72 x 12 P	72 x 12 1/4	FIXED	4.5	0	6.13	56.25	
W-30	75 x 12 P	75 x 12 1/4	FIXED	4.71	0	6.38	58.875	
W-31	PRISM	62 1/2 x15 x 26 1/2 x 15	FIXED PENTAGON	4.7	0	4.76	58.75	
W-46	30x12 P	30 1/2 x 12 1/2	FIXED	1.89	0	2.65	23.625	
W-48	36 x 25 P	36 1/2 x 25	FIXED	5.17	0	6.33	64.625	
W-49	30 x 25 P	30 1/2 x 25	FIXED	4.24	0	5.3	53	
W-50	46 x 25 P	46 1/2 x 25	FIXED	6.7	0	8.07	83.75	
W-57		28 x 4 1/2 x 23 1/2	FW TRAP	1.9	0	2.7	23.75	
W-58		28 x 23 1/2 x 4 1/2	FW TRAP	1.9	0	6.2	23.75	
W-59		28 x 27 1/4 x 36 1/2 x 27 1/4	FIXED PENTAGON	5.1	0	2.7	63.75	
W-89	24 x 14 P	24 1/2 x 14 1/4	FIXED	1.71	0	2.42	21.375	
W-90	36 x 14 P	36 1/2 x 14 1/4	FIXED	2.66	0	4.6	33.25	
W-92	73 x 14 P	73 1/4 x 14 1/4	FIXED	5.56	0	7.25	69.5	

CuttingEdgeHomes.Net

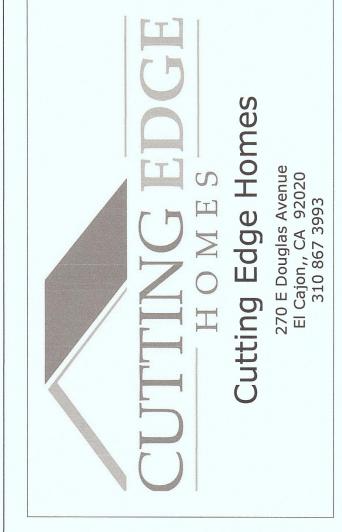



THESE CONSTRUCTION DOCUMENTS CREATED BY CUTTING EDGE HOMES ARE AN INSTRUMENT OF SERVICE PROVIDED TO THE OWNER BY THE DESIGNER. THESE DOCUMENTS ARE OWNED BY THE DESIGNER AND COPIES FOR APPROPRIATE PERMITS AND CONSTRUCTION SHALL BE PROVIDED TO THE OWNER. THESE DOCUMENTS SHALL NOT BE USED FOR ANY PROJECT OTHER THAN THE SPECIFIC PROJECT CONTRACT FOR. NO EXCEPTIONS.

No.	Description	Date
Α	PRELIMINARY DESIGN	2015.09
В	REVISED DRAWINGS	2015.10
С	PLANNING SUBMITTAL	2015.12
D	PLANNING CHANGES	2016.05

LIN & JIANG RESIDENCE 2 STORY HOME Window Schedule

Drawn by	2015-09-16 Author
Checked by	Checker

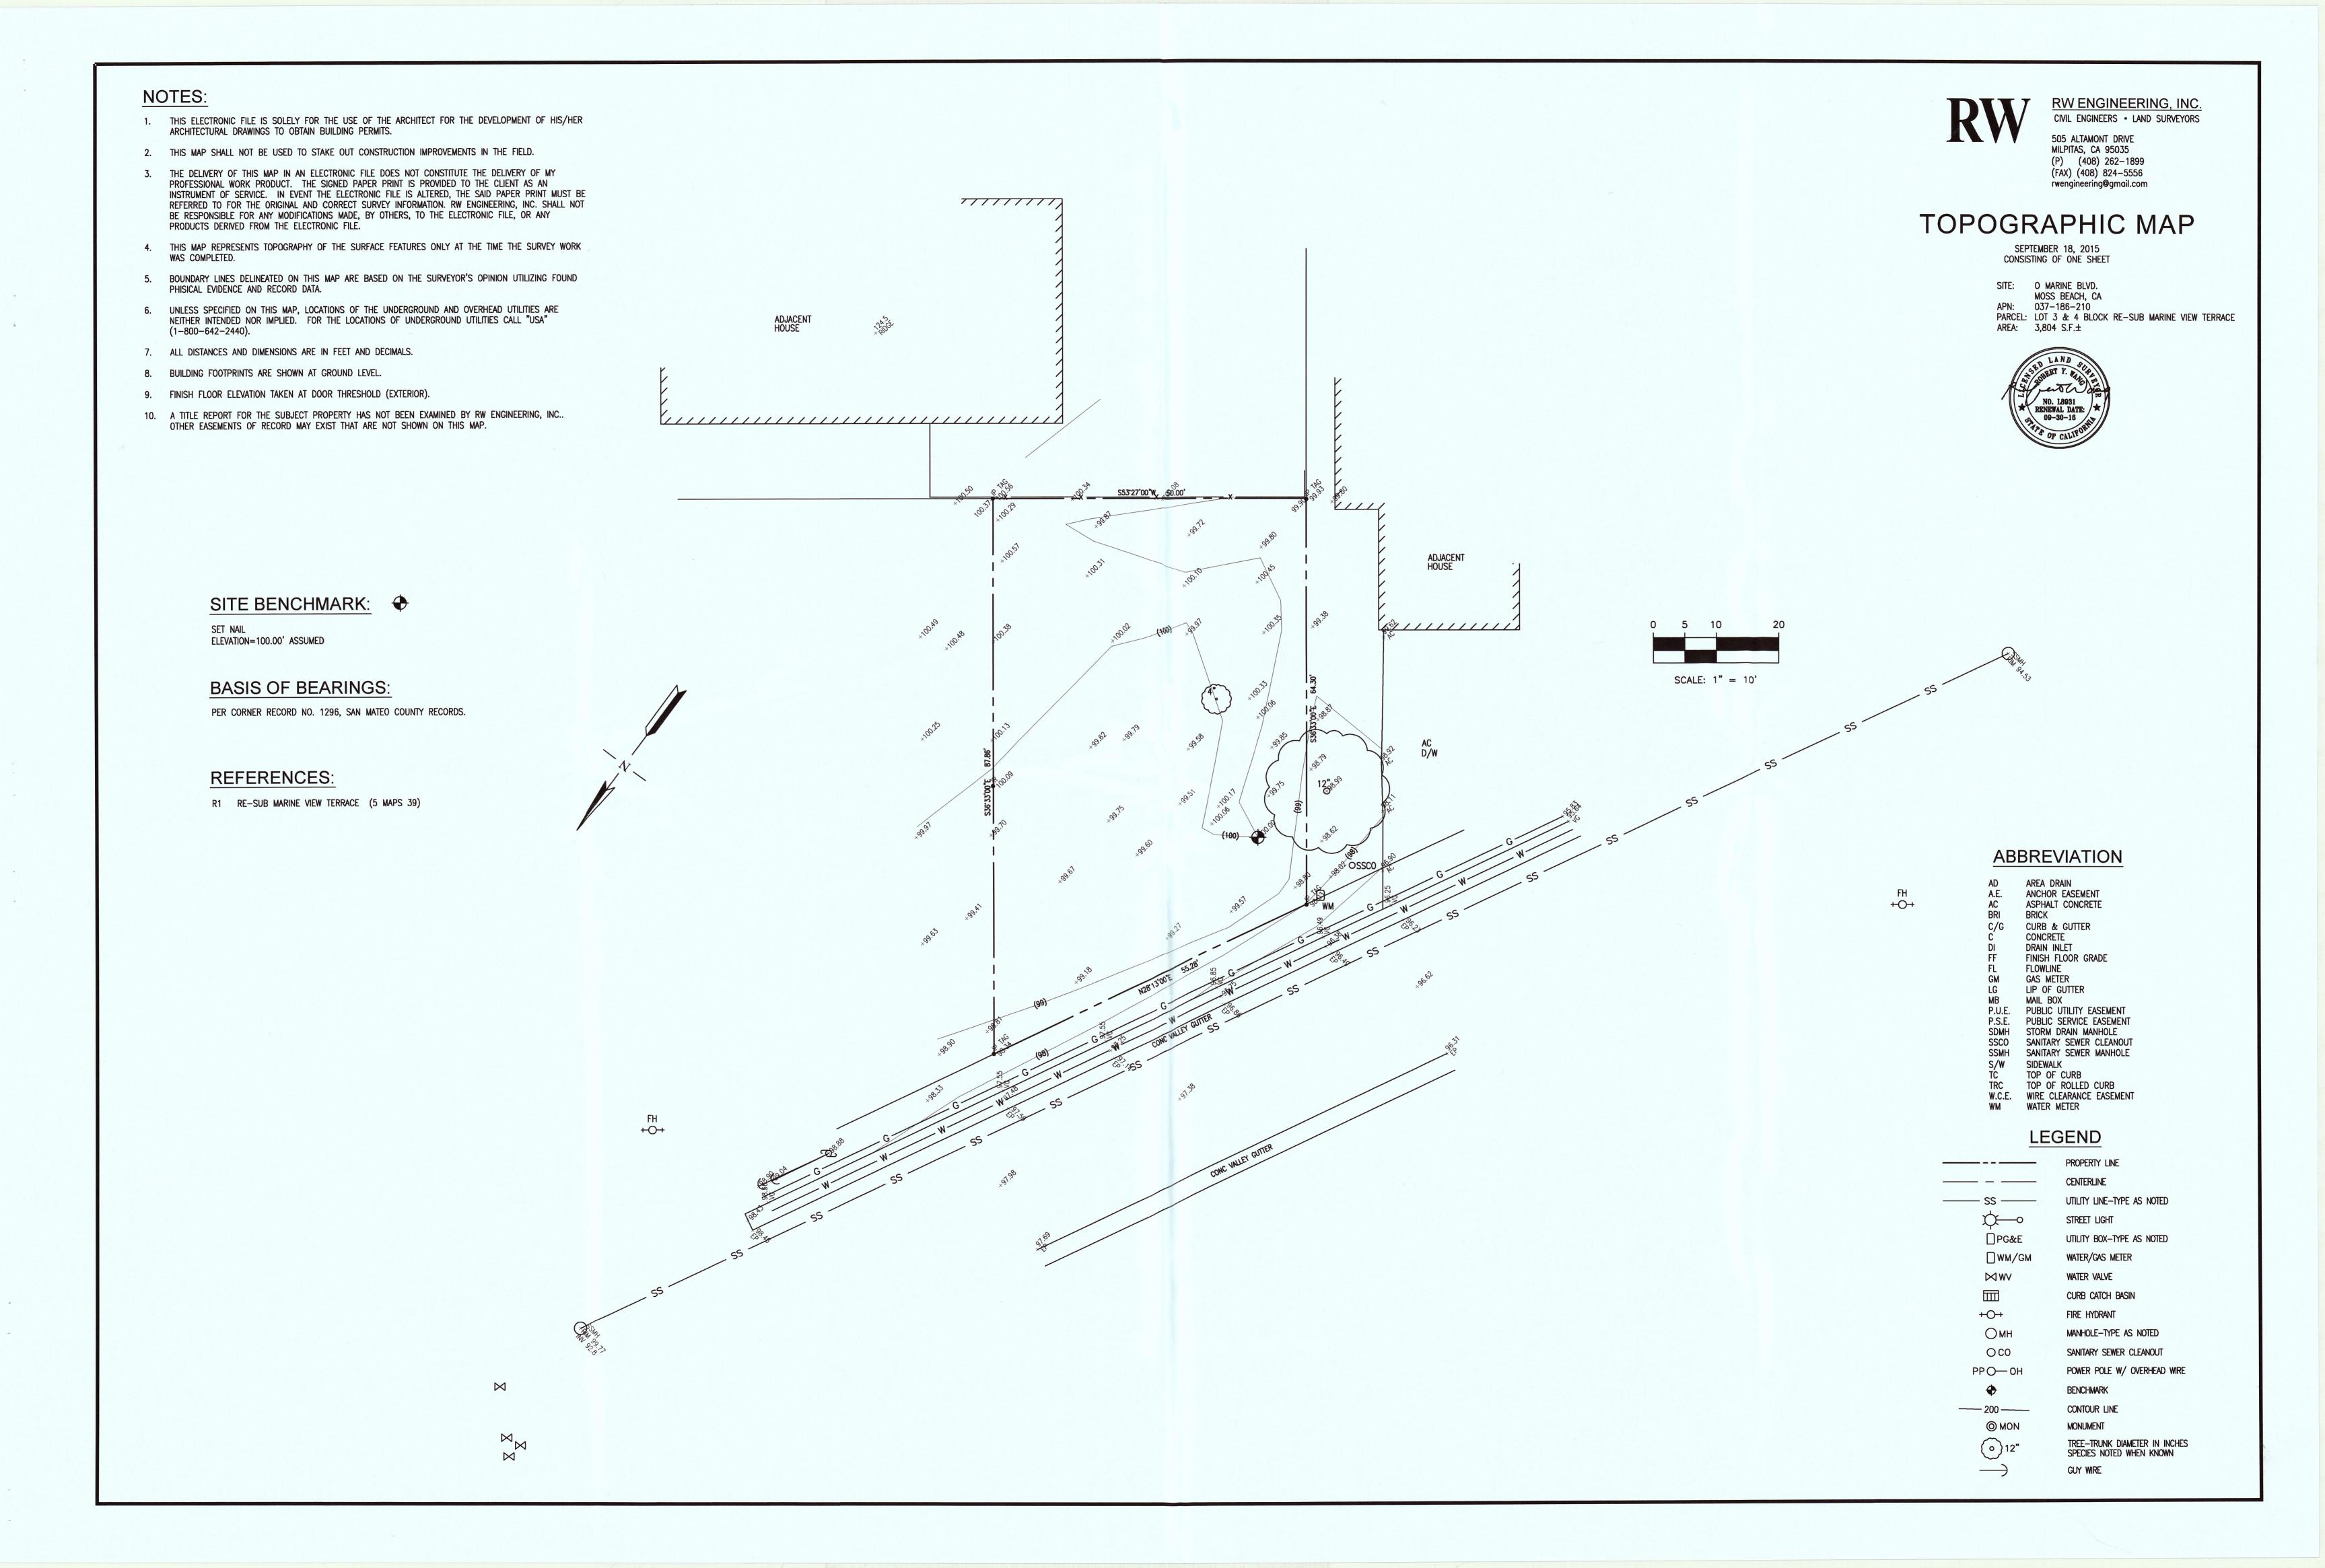

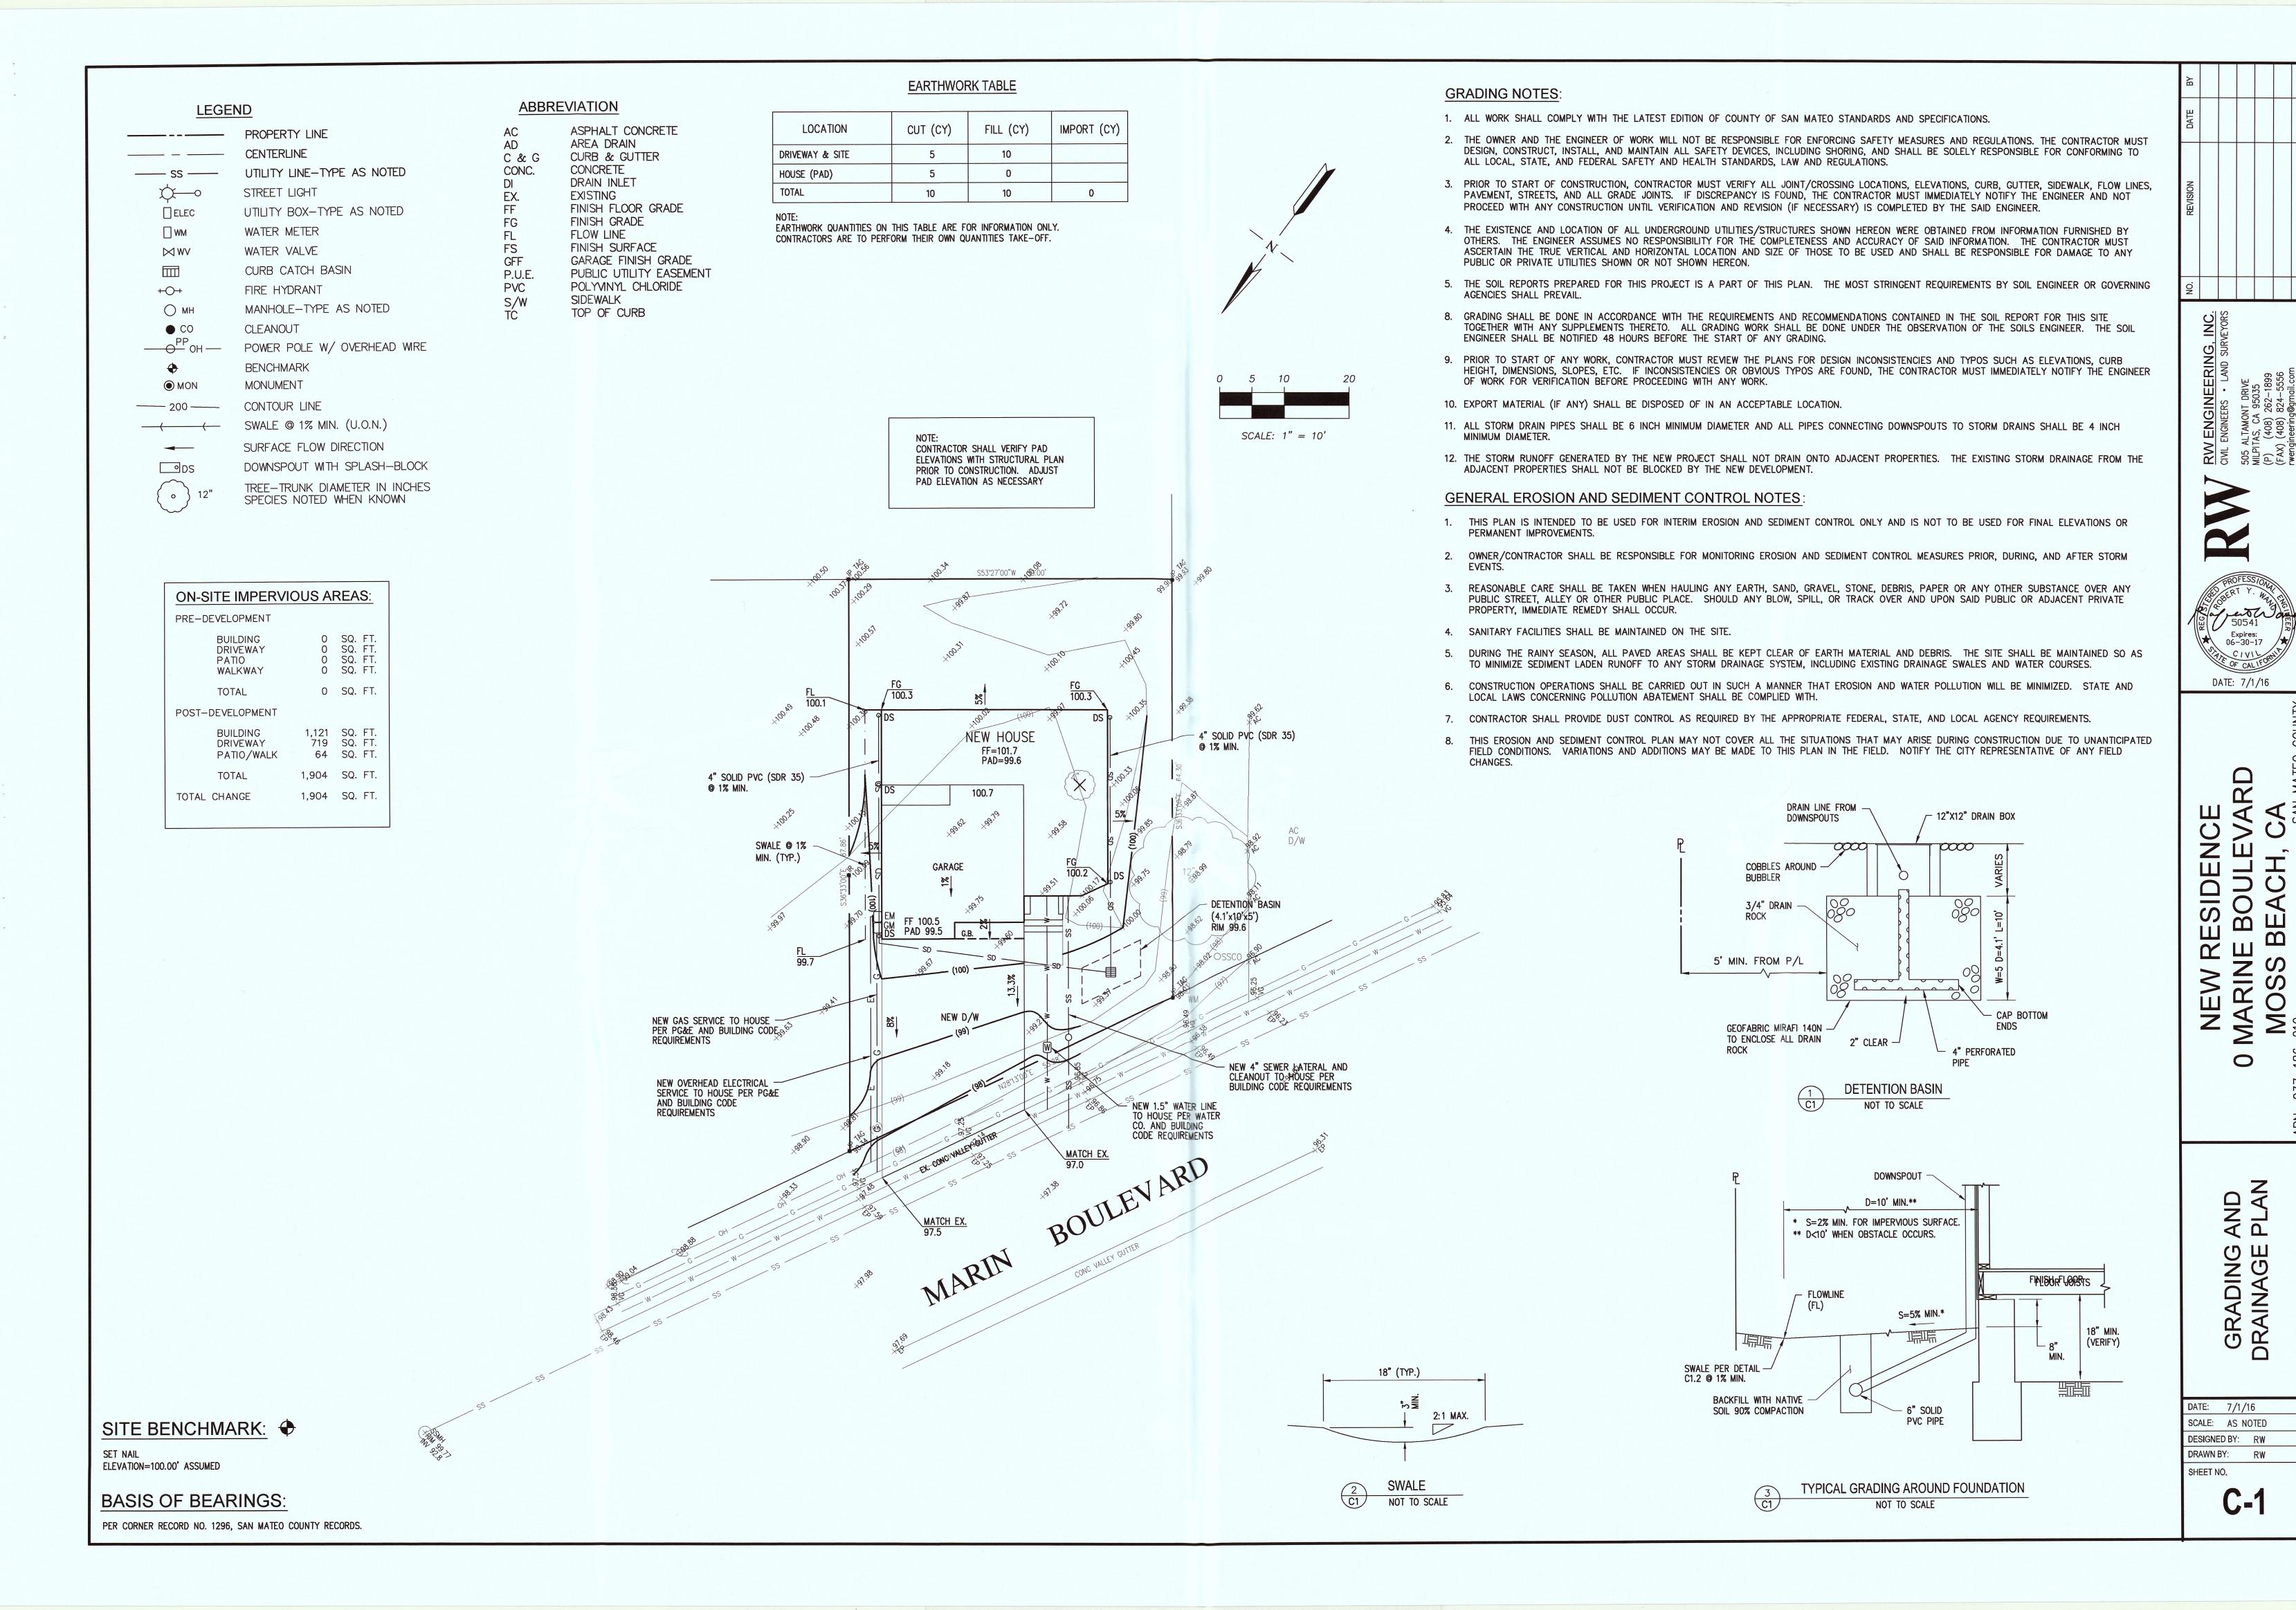

#### GENERAL EROSION AND SEDIMENT CONTROL NOTES:

- 1. THIS PLAN IS INTENDED TO BE USED FOR INTERIM EROSION AND SEDIMENT CONTROL ONLY AND IS NOT TO BE USED FOR FINAL ELEVATIONS OR PERMANENT IMPROVEMENTS.
- 2. OWNER/ CONTRACTOR SHALL BE RESPONSIBLE FOR MONITORING EROSION AND SEDIMENT CONTROL MEASURES PRIOR, DURING, AND AFTER STORM
- 3. REASONABLE CARE SHALL BE TAKEN WHEN HAULING ANY EARTH, SAND, GRAVEL, STONE, DEBRIS, PAPER OR ANY OTHER SUBSTANCE OVER ANY PUBLIC STREET, ALLEY OR OTHER PUBLIC PLACE. SHOULD ANY BLOW, SPILL, OR TRACK OVER AND UPON SAID PUBLIC OR ADJACENT PRIVATE PROPERTY, IMMEDIATE REMEDY SHALL OCCUR.
- 4. SANITARY FACILITIES SHALL BE MAINTAINED ON THE SITE.
- 5. DURING THE RAINY SEASON, ALL PAVED AREAS SHALL BE KEPT CLEAR OF EARTH MATERIAL AND DEBRIS. THE SITE SHALL BE MAINTAINED SO AS TO MINIMIZE SEDIMENT LADEN RUNOFF TO ANY STORM DRAINAGE SYSTEM, INCLUDING EXISTING DRAINAGE SWALES AND WATER COURSES.
- 6. CONSTRUCTION OPERATIONS SHALL BE CARRIED OUT IN SUCH A MANNER THAT EROSION AND WATER POLLUTION WILL BE MINIMIZED. STATE AND LOCAL LAWS CONCERNING POLLUTION ABATEMENT SHALL BE COMPLIED WITH.
- 7. CONTRACTOR SHALL PROVIDE DUST CONTROL AS REQUIRED BY THE APPROPRIATE FEDERAL, STATE, AND LOCAL AGENCY REQUIREMENTS.

#### EROSION AND SEDIMNET CONTROL MEASURES

- 1. THE FACILITIES SHOWN ON THIS PLAN ARE DESIGNED TO CONTROL EROSION AND SEDIMENT DURING THE RAINY SEASON, OCTOBER 15 TO APRIL 15. FACILITIES ARE TO BE OPERABLE PRIOR TO OCTOBER 1 OF ANY YEAR. GRADING OPERATIONS DURING THE RAINY SEASON WHICH LEAVE DENUDED SLOPES SHALL BE PROTECTED WITH EROSION CONTROL MEASURES IMMEDIATELY FOLLOWING GRADING ON THE SLOPES.
- 2. THIS PLAN COVERS ONLY THE FIRST WINTER FOLLOWING GRADING WITH ASSUMED SITE CONDITIONS AS SHOWN ON THE EROSION CONTROL PLAN. PRIOR TO SEPTEMBER 15, THE COMPLETION OF SITE IMPROVEMENT SHALL BE EVALUATED AND REVISIONS MADE TO THIS PLAN AS NECESSARY WITH THE APPROVAL OF THE CITY ENGINEER. PLANS ARE TO BE RESUBMITTED FOR CITY APPROVAL PRIOR TO SEPTEMBER 1 OF EACH SUBSEQUENT YEAR UNTIL SITE IMPROVEMENTS ARE ACCEPTED BY THE CITY AND COUNTY.
- 3. CONSTRUCTION ENTRANCES SHALL BE INSTALLED PRIOR TO COMMENCEMENT OF GRADING. ALL CONSTRUCTION TRAFFIC ENTERING ONTO THE PAVED ROADS MUST CROSS THE STABILIZED CONSTRUCTION ENTRANCE WAYS. (ALSO INCLUDE THIS NOTE ON GRADING PLANS.)
- 4. CONTRACTOR SHALL MAINTAIN STABILIZED ENTRANCE AT EACH VEHICLE ACCESS POINT TO EXISTING PAVED STREETS. ANY MUD OR DEBRIS TRACKED ONTO PUBLIC STREETS SHALL BE REMOVED DAILY AND AS REQUIRED BY THE CITY AND COUNTY.
- 5. IF HYDROSEEDING IS NOT USED OR IS NOT EFFECTIVE BY 10/10, THEN OTHER IMMEDIATE METHODS SHALL BE IMPLEMENTED, SUCH AS EROSION CONTROL BLANKETS, OR A THREE-STEP APPLICATION OF 1) SEED, MULCH, FERTILIZER 2) BLOWN STRAW 3) TACKIFIER AND MULCH.
- 6. INLET PROTECTION SHALL BE INSTALLED AT OPEN INLETS TO PREVENT SEDIMENT FROM ENTERING THE STORM DRAIN SYSTEM. INLETS NOT USED IN CONJUNCTION WITH EROSION CONTROL ARE TO BE BLOCKED TO PREVENT ENTRY OF SEDIMENT.
- 7. LOTS WITH HOUSES UNDER CONSTRUCTION WILL NOT BE HYDROSEEDED. EROSION PROTECTION FOR EACH LOT WITH A HOUSE UNDER CONSTRUCTION SHALL CONFORM TO THE TYPICAL LOT EROSION CONTROL DETAIL SHOWN ON THIS SHEET.
- 8. THIS EROSION AND SEDIMENT CONTROL PLAN MAY NOT COVER ALL THE SITUATIONS THAT MAY ARISE DURING CONSTRUCTION DUE TO UNANTICIPATED FIELD CONDITIONS. VARIATIONS AND ADDITIONS MAY BE MADE TO THIS PLAN IN THE FIELD. NOTIFY THE CITY REPRESENTATIVE OF ANY FIELD

#### MAINTENANCE NOTES


- 1. MAINTENANCE IS TO BE PERFORMED AS FOLLOWS:
- A. REPAIR DAMAGES CAUSED BY SOIL EROSION OR CONSTRUCTION AT THE END OF EACH WORKING DAY.
- B. SWALES SHALL BE INSPECTED PERIODICALLY AND MAINTAINED AS NEEDED.
- C. SEDIMENT TRAPS, BERMS, AND SWALES ARE TO BE INSPECTED AFTER EACH STORM AND REPAIRS MADE AS NEEDED. D. SEDIMENT SHALL BE REMOVED AND SEDIMENT TRAP RESTORED TO ITS ORIGINAL DIMENSIONS WHEN SEDIMENT HAS ACCUMULATED TO A DEPTH OF 1
- E. SEDIMENT REMOVED FROM TRAP SHALL BE DEPOSITED IN A SUITABLE AREA AND IN SUCH A MANNER THAT IT WILL NOT ERODE.
- F. RILLS AND GULLIES MUST BE REPAIRED. 2. ROCK BAG INLET PROTECTION SHALL BE CLEANED OUT WHENEVER SEDIMENT DEPTH IS ONE HALF THE HEIGHT OF ONE GRAVEL BAG.

#### HYDROSEEDING:

- ALL WORK SHALL BE PERFORMED IN ACCORDANCE WITH THE MANUFACTURER'S RECOMMENDATIONS, CALTRANS STANDARD SPECIFICATIONS, AND UNDER THE DIRECTION OF THE SOIL ENGINEER IN THE FIELD.
- 2. ALL AREAS SPECIFIED FOR HYDROSEEDING SHALL BE NOZZLE PLANTED WITH STABILIZATION MATERIAL CONSISTING OF FIBER, SEED, FERTILIZER AND WATER, MIXED AND APPLIED IN THE FOLLOWING PROPORTIONS AVAILABLE FROM PACIFIC COAST SEED, LIVERMORE (925) 373-4417:

FIBER (HYDROSTRAW AND TACK MULCH) COLOR (GREEN TO GOLD) FERTILIZER (16-20-0) WATER, AS REQUIRED FOR APPLICATION

2500 LBS/ACRE 55 LBS/ACRE 350 LBS/ACRE 125 LB/ACRE

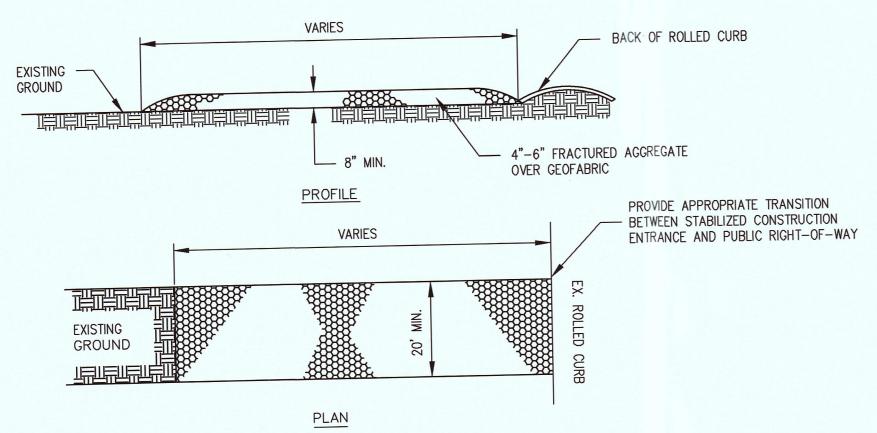

APPROVED SEDIMENT TRAP OR SEDIMENT BASIN.

- MAINTENANCE: 1. THE ENTRANCE SHALL BE MAINTAINED IN A CONDITION THAT WILL PREVENT TRACKING OR FLOWING SEDIMENT ONTO PUBLIC RIGHT-OF-WAY. THIS MAY REQUIRE PERIODIC DRESSING WITH ADDITIONAL STONE AS CONDITIONS DEMAND, AND
- REPAIR AND/OR CLEAN OUT ANY MEASURES USED TO TRAP SEDIMENT. ALL SEDIMENT SPILLED, DROPPED, WASHED, OR TRACKED ONTO PUBLIC RIGHT-OF-WAY SHALL BE REMOVE IMMEDIATELY. WHEN NECESSARY, WHEELS SHALL BE CLEANED TO REMOVE SEDIMENT PRIOR TO ENTRANCE ONTO PUBLIC RIGHT-OF-WAY. THIS SHALL BE DONE AT AN AREA STABILIZED WITH CRUSHED STONE, WHICH DRAINS INTO AN

STABILIZED CONSTRUCTION ENTRANCE

ADDITONAL NOTES:

- 1. STABILIZE ALL DENUDED AREAS AND INSTALL AND MAINTAIN ALL TEMPORARY EROSION AND SEDIMENT CONTROLS CONTINUOUSLY BETWEEN OCTOBER 15TH AND APRIL 15TH OF EACH YEAR, UNTIL PERMANENT EROSION CONTROL HAVE BEEN ESTABLISHED.
- 2. STORE, HANDLE, AND DISPOSE OF CONSTRUCTION MATERIALS AND WASTE PROPERLY, SO AS TO PREVENT THEIR CONTACT WITH STORMWATER.
- 3. CONTROL AND PREVENT THE DISCHARGE OF ALL POTENTIAL POLLUTANTS, INCLUDING PAVEMENT CUTTING, WASTES, PAINTS, CONCRETE, PETROLEUM PRODUCTS, CHEMICALS, WASHWATER OR SEDIMENTS, AND NON-STORMWATER DISCHARGES TO STORM DRAINS AND WATERCOURSES.
- 4. USE SEDIMENT CONTROLS OR FILTRATION TO REMOVE SEDIMENT WHEN DETWATERING SITE AND OBTAIN ALL NECESSARY PERMITS.
- 5. AVOID CLEANING, FUELING, OR MAINTENING VEHICLE ON-SITE, EXCEPT IN A DESIGNATED AREA WHERE WASHWATER IS CONTAINED AND TREATED.
- 6. DELINEATE WITH FIELD MARKERS CLEARING LIMITS, EASEMENTS, SETBACKS, SENSITIVE OR CRITICAL AREAS, BUFFER ZONES, TREES AND DRAINAGE
- 7. PROTECT ADJACENT PROPERTIES AND UNDISTURBED AREAS FROM CONSTRUCTION IMPACTS USING VEGETATIVE BUFFER STRIPS, SEDIMENT BARRIERS OR FILTERS, DIKES, MULCHING, OR OTHER MEASURES AS APPROPRIATE.
- 8. PERFORM CLEARING AND EARTH MOVING ACTIVITIES ONLY DURING DRY WEATHER.
- 9. LIMIT AND TIME APPLICATIONS OF PESTICIDES AND FERTILIZERS TO PREVENT POLLUTED RUNOFF.
- 10. LIMIT CONSTRUCTION ACCESS ROUTES AND STABILIZE DESIGNATED ACCESS POINTS.
- 11. AVOID TRACKING DIRT OR OTHER MATERIAL OFF-SITE; CLEAN OFF-SITE PAVED AREAS AND SIDEWALKS USING DRY SWEEPING METHODS.
- 12. THE CONTRACTOR SHALL TRAIN AND PROVIDE INSTRUCTION TO ALL EMPLOYEES AND SUBCONTRACTORS REGARDING THE CONSTRUCTION BMPS.

CONTRACTOR SHALL HYDROSEED OR COVER WITH JUTE MAT ALL GRADED & EXPOSED AREA DURING CONSTRUCTION UNTIL PERMANENT EROSION AND SEDIMENT CONTROL ARE INSTALLED - GRADING ? CONSTRUCTION MATERIAL STORAGE AREA NEW HOUSE GARAGE CONCRETE WASH AREA ROCKED CONSTRUCTION ENTRANCE AND PARKING NEW DXW PORTABLE TOTLET ROCK BAGO CHECK DAM

SEDIMENT/EROSION CONTROL MEASURES SHOWN ON THIS SHEET ARE THE MINIMUM REQUIREMENTS. IT IS THE CONTRACTOR'S RESPONSIBILITY TO PROVIDE ADDITIONAL SEDIMENT/EROSION CONTROL MEASURES AS DEEMED NECESSARY TO ASSURE ADEQUATE PROTECTION DURING THE PROGRESS OF CONSTRUCTION AND AT THE CONTRACTOR'S EXPENSE.

Expires: 06-30-17

DATE: 7/1/16

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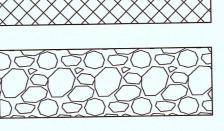
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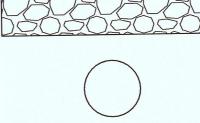
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LEGEND




SILT FENCE




CONCRETE WASH AREA


CONSTRUCTION ENTRANCE

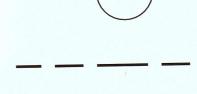

GRADING/DISTURBED AREA LIMITS

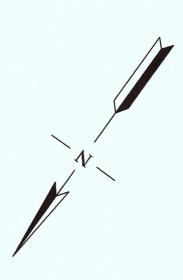

SCALE: 1" = 10'

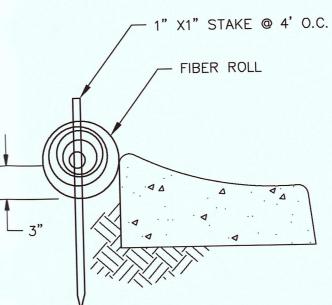

FIBER ROLL NOT TO SCALE

SHEET NO. **C-2** 

DRAWN BY:

DATE: 7/1/16

SCALE: AS NOTED

DESIGNED BY: RW




## Construction Best Management Practices (BMPs)

Construction projects are required to implement the stormwater best management practices (BMP) on this page, as they apply to your project, all year long.

Clean Water. Healthy Community.

#### Materials & Waste Management

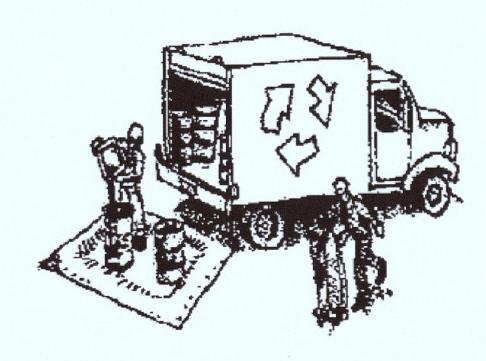

#### Non-Hazardous Materials

- ☐ Berm and cover stockpiles of sand, dirt or other construction material with tarps when rain is forecast or if not actively being used within 14 days
- ☐ Use (but don't overuse) reclaimed water for dust control.

#### **Hazardous Materials**

- ☐ Label all hazardous materials and hazardous wastes (such as pesticides, paints, thinners, solvents, fuel, oil, and antifreeze) in accordance with city, county, state and federal regulations.
- ☐ Store hazardous materials and wastes in water tight containers, store in appropriate secondary containment, and cover them at the end of every work day or during wet weather or when rain is forecast.
- ☐ Follow manufacturer's application instructions for hazardous materials and be careful not to use more than necessary. Do not apply chemicals outdoors when rain is forecast within 24 hours.
- ☐ Arrange for appropriate disposal of all hazardous wastes.

#### **Waste Management**

- ☐ Cover waste disposal containers securely with tarps at the end of every work day and during wet weather.
- ☐ Check waste disposal containers frequently for leaks and to make sure they are not overfilled. Never hose down a dumpster on the construction site.
- ☐ Clean or replace portable toilets, and inspect them frequently for leaks and spills.
- ☐ Dispose of all wastes and debris properly. Recycle materials and wastes that can be recycled (such as asphalt, concrete, aggregate base materials, wood, gyp board, pipe, etc.)
- ☐ Dispose of liquid residues from paints, thinners, solvents, glues, and cleaning fluids as hazardous waste.

#### **Construction Entrances and Perimeter**

- ☐ Establish and maintain effective perimeter controls and stabilize all construction entrances and exits to sufficiently control erosion and sediment discharges from site and tracking off site.
- ☐ Sweep or vacuum any street tracking immediately and secure sediment source to prevent further tracking. Never hose down streets to clean up tracking.

### **Equipment Management & Spill Control**




#### **Maintenance and Parking**

- ☐ Designate an area, fitted with appropriate BMPs, for vehicle and equipment parking and storage.
- ☐ Perform major maintenance, repair jobs, and vehicle and equipment washing off site.
- ☐ If refueling or vehicle maintenance must be done onsite, work in a bermed area away from storm drains and over a drip pan or drop cloths big enough to collect fluids. Recycle or dispose of fluids as hazardous waste.
- ☐ If vehicle or equipment cleaning must be done onsite, clean with water only in a bermed area that will not allow rinse water to run into gutters, streets, storm drains, or surface waters.
- Do not clean vehicle or equipment onsite using soaps, solvents, degreasers, or steam cleaning equipment.

#### **Spill Prevention and Control**

- ☐ Keep spill cleanup materials (e.g., rags, absorbents and cat litter) available at the construction site at all times.
- ☐ Inspect vehicles and equipment frequently for and repair leaks promptly. Use drip pans to catch leaks until repairs are made.
- ☐ Clean up spills or leaks immediately and dispose of cleanup materials properly.
- ☐ Do not hose down surfaces where fluids have spilled. Use dry cleanup methods (absorbent materials, cat litter, and/or rags).
- Sweep up spilled dry materials immediately. Do not try to wash them away with water, or bury them.
- ☐ Clean up spills on dirt areas by digging up and properly disposing of contaminated soil.
- Report significant spills immediately. You are required by law to report all significant releases of hazardous materials, including oil. To report a spill: 1) Dial 911 or your local emergency response number, 2) Call the Governor's Office of Emergency Services Warning Center, (800) 852-7550 (24 hours).

#### **Earthmoving**

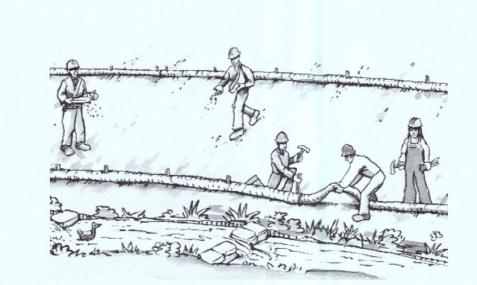


- ☐ Schedule grading and excavation work during dry weather.
- ☐ Stabilize all denuded areas, install and maintain temporary erosion controls (such as erosion control fabric or bonded fiber matrix) until vegetation is established.
- ☐ Remove existing vegetation only when absolutely necessary, and seed or plant vegetation for erosion control on slopes or where construction is not immediately planned.
- ☐ Prevent sediment from migrating offsite and protect storm drain inlets, gutters, ditches, and drainage courses by installing and maintaining appropriate BMPs, such as fiber rolls, silt fences, sediment basins, gravel bags, berms, etc.
- ☐ Keep excavated soil on site and transfer it to dump trucks on site, not in the streets.

#### **Contaminated Soils**

- ☐ If any of the following conditions are observed, test for contamination and contact the Regional Water Quality Control Board:
- Unusual soil conditions, discoloration, or odor.
- Abandoned underground tanks.
- Abandoned wells
- Buried barrels, debris, or trash.

#### Paving/Asphalt Work

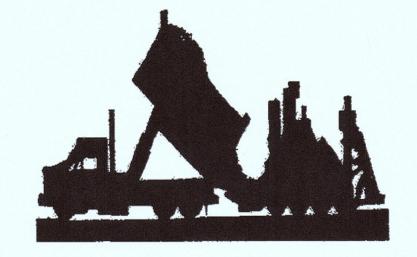

- Avoid paving and seal coating in wet weather or when rain is forecast, to prevent materials that have not cured from contacting stormwater runoff.
- ☐ Cover storm drain inlets and manholes when applying seal coat, tack coat, slurry seal, fog seal, etc.
- ☐ Collect and recycle or appropriately dispose of excess abrasive gravel or sand. Do NOT sweep or wash it into gutters.
- ☐ Do not use water to wash down fresh asphalt concrete pavement.

#### Sawcutting & Asphalt/Concrete Removal


- ☐ Protect nearby storm drain inlets when saw cutting. Use filter fabric, catch basin inlet filters, or gravel bags to keep slurry out of the storm drain system.
- Shovel, abosorb, or vacuum saw-cut slurry and dispose of all waste as soon as you are finished in one location or at the end of each work day (whichever is sooner!).
- ☐ If sawcut slurry enters a catch basin, clean it up immediately.

#### Concrete, Grout & Mortar Application




- ☐ Store concrete, grout, and mortar away from storm drains or waterways, and on pallets under cover to protect them from rain, runoff, and wind.
- ☐ Wash out concrete equipment/trucks offsite or in a designated washout area, where the water will flow into a temporary waste pit, and in a manner that will prevent leaching into the underlying soil or onto surrounding areas. Let concrete harden and dispose of as garbage.
- ☐ When washing exposed aggregate, prevent washwater from entering storm drains. Block any inlets and vacuum gutters, hose washwater onto dirt areas, or drain onto a bermed surface to be pumped and disposed of properly.

#### Landscaping

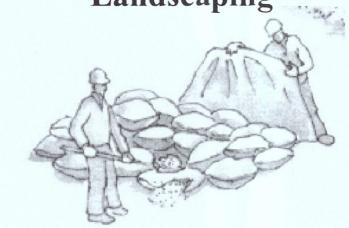

- ☐ Protect stockpiled landscaping materials from wind and rain by storing them under tarps all year-round.
- ☐ Stack bagged material on pallets and under cover.
- ☐ Discontinue application of any erodible landscape material within 2 days before a forecast rain event or during wet weather.

#### Painting & Paint Removal

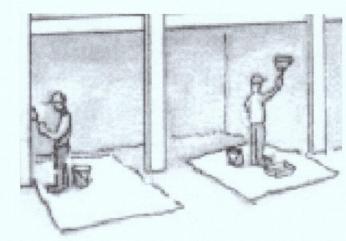


#### **Painting Cleanup and Removal**

- ☐ Never clean brushes or rinse paint containers into a street, gutter, storm drain, or stream.
- ☐ For water-based paints, paint out brushes to the extent possible, and rinse into a drain that goes to the sanitary sewer.

  Never pour paint down a storm drain.
- ☐ For oil-based paints, paint out brushes to the extent possible and clean with thinner or solvent in a proper container. Filter and reuse thinners and solvents. Dispose of excess liquids as hazardous waste.
- Paint chips and dust from non-hazardous dry stripping and sand blasting may be swept up or collected in plastic drop cloths and disposed of as trash.
- ☐ Chemical paint stripping residue and chips and dust from marine paints or paints containing lead, mercury, or tributyltin must be disposed of as hazardous waste.

  Lead based paint removal requires a statecertified contractor.


#### **Dewatering**

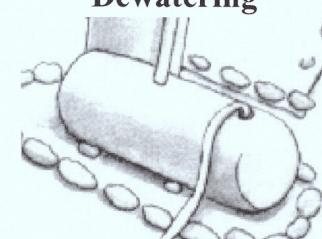

- Discharges of groundwater or captured runoff from dewatering operations must be properly managed and disposed. When possible send dewatering discharge to landscaped area or sanitary sewer. If discharging to the sanitary sewer call your local wastewater treatment plant.
- ☐ Divert run-on water from offsite away from all disturbed areas.
- When dewatering, notify and obtain approval from the local municipality before discharging water to a street gutter or storm drain. Filtration or diversion through a basin, tank, or sediment trap may be required.
- ☐ In areas of known or suspected contamination, call your local agency to determine whether the ground water must be tested. Pumped groundwater may need to be collected and hauled off-site for treatment and proper disposal.

Storm drain polluters may be liable for fines of up to \$10,000 per day!

# Landscape Plan

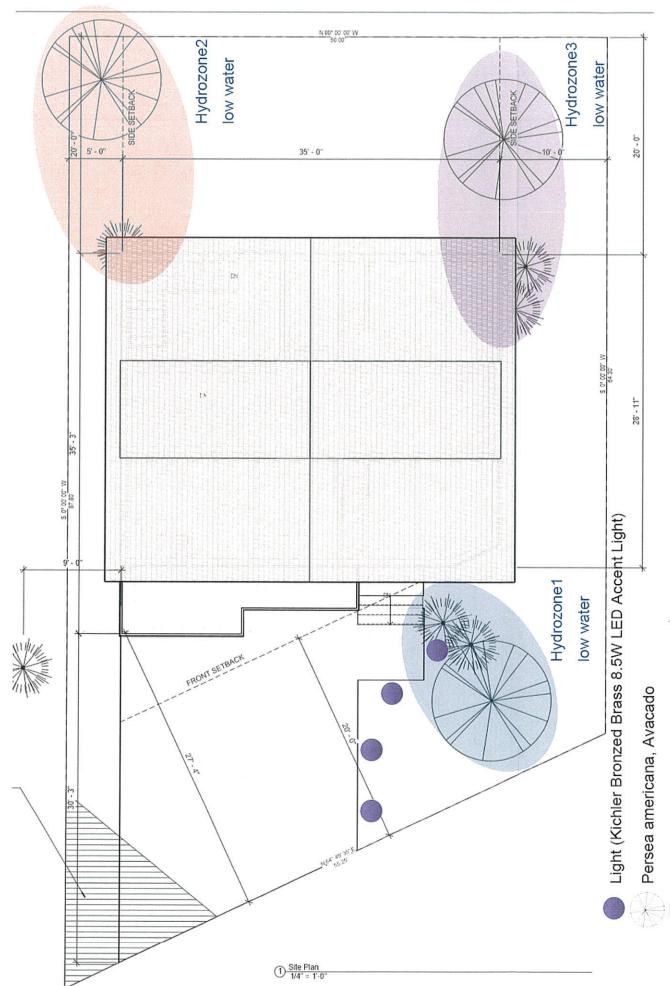

Sedum


Sedum spp. stonecrop

- \* Total Landscape Area: 1250SQ.FT
- $^{\star}$  2-inch compost will be uniformly applied to the hydrozone 480 SQ FT
- 1 inches compost will be uniformly applied to all the other landscape area 770 SQ FT Compost rate(cubic yard/1000sqft): (6.2\*480+3.1\*770)/1250=4.30
- A minimum 3-inch layer of mulch will be applied on all exposed soil surfaces of planting areas except turf areas, creeping or rooting groundcovers, or direct seeding applications where mulch is contraindicated."
  - At the time of final inspection, the permit applicant must provide the owner of the property with a certificate of completion, certificate of installation, irrigation schedule of landscape and irrigation maintenance
- Unless contradicted by a soils test, compost at a rate of a minimum of four cubic yards per 1,000 square feet of permeable area shall be incorporated to a depth of six inches into the soil"
- We have complied with the criteria of the ordinance and applied them for the efficient use of water in the landscape design plans.

Signature: Chuyen on The Date: 08/16/2016

PLH206-00429

# Irrigation Plan

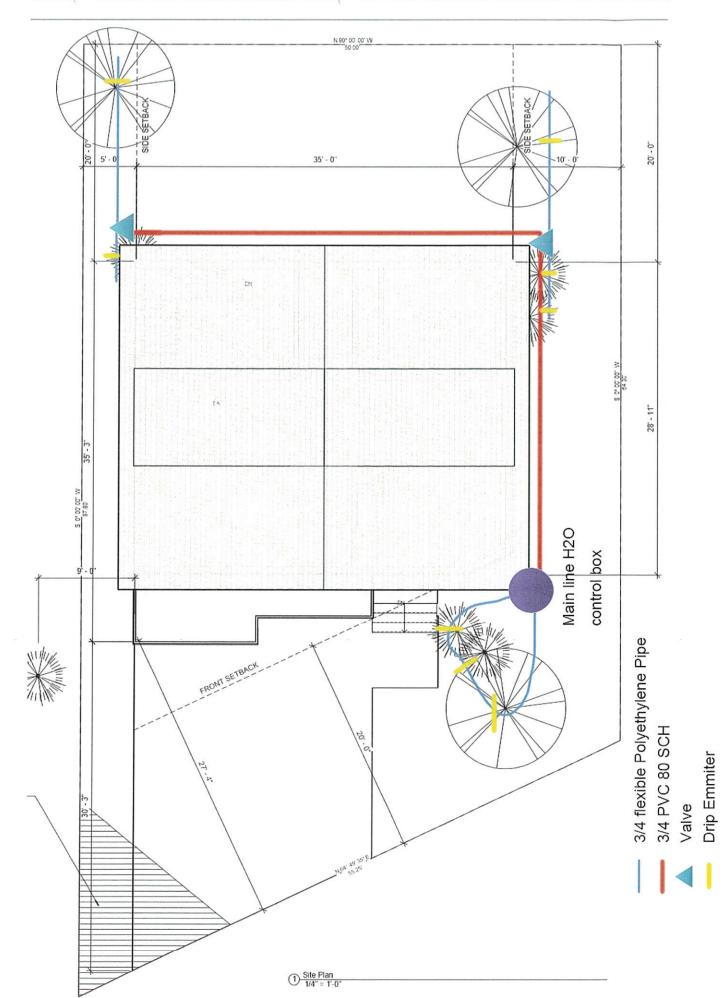

\* Static water pressure: 50 PSI

\* Main Line Control Box

1. Smart Irrigation system: Smart irrigation controller + Soil moisture sensor

2. Drip system

Flow rate: 1 gallon per hour

Valveball: valve

Backflow preventor: Pressure Vacuum Breaker (PVB)

Pressure regulator: 25 psi 3/4 in. Pipe thread pressure regulator

Filter: Orbit drip irrigation water filter (3/4" Pipe Thread)

Drip tubing: 3/4" flexible Polyethylene Pipe

Emmiter Short-Path Emitters

\* We have complied with the criteria of the ordinance and applied them for the efficient use of water in the landscape design plans.

Signature: Chuwen di Ann Ja

Date: 08/26/2016